



AMERICAN TOWER®

ATC SITE NAME: COVENTRY SPRING LAKE RI ATC SITE NUMBER: 415799 T-MOBILE SITE NAME: 4PR0700A T-MOBILE SITE NUMBER: 4PR0700A SITE ADDRESS: 60 WOOD STREET COVENTRY, RI 02816 SITE CLASS: MONOPOLE



LOCATION MAP

T-MOBILE COVERAGE STRATEGY COLLOCATION PLAN 67E5D998E 6160 CONFIGURATION

COMPLIANCE CODE	PROJECT SUMMARY	PROJECT DESCRIPTION	SHEET				
WORK SHALL BE PERFORMED AND MATERIALS SITE ADDRESS:		THE PROPOSED PROJECT INCLUDES INSTALLING EQUIPMENT CABINETS AND A GENERATOR ON A PROPOSED CONCRETE PAD		DESCRIPTION:	REV:	DATE:	BY:
OF THE FOLLOWING CODES AS ADOPTED BY THE LOCAL GOVERNMENT AUTHORITIES. NOTHING IN THESE PLANS IS	COVENTRY, RI 02816 COUPOUND, A COUNTY: KENT THE EXISTING <u>GEOGRAPHIC COORDINATES:</u> INSTALL(1) PLA LATITUDE: 41.68636277 HYBRID TRUNK 41° 41' 10.906" N LONGITUDE: -71.56334458 GROUND SCOL 71° 33' 48.04" W GPS ANTENNA GROUND ELEVATION: 229' AMSL (1) AAV CABINE SWITCH/TIMEF	INSIDE A 10' X 15' GROUND SPACE WITHIN THE EXISTING COMPOUND, AND INSTALLING NEW EQUIPMENT AND MOUNTS ON	G-001	TITLE SHEET	0	04/14/25	JMB
TO BE CONSTRUED TO PERMIT WORK NOT CONFORMING TO THESE CODES.		THE EXISTING TOWER.	G-002	GENERAL NOTES	0	04/14/25	JMB
2018 IBC NATIONAL ELECTRICAL CODE (NFPA 70, NEC 2020 W/ AMND) 2021 RHODE ISLAND MECHANICAL CODE (IMC 2018 W/ AMND) 2021 RHODE ISLAND PLUMBING CODE (IPC 2018 W/ AMND) 2021 STATE OF RHODE ISLAND ENERGY CONSERVATION CODE (IECC 2018 W/ AMND) FIRE CODE (IFCP 1, 2018 W/ AMND)		INSTALL(1) PLATFORM, (9) ANTENNA(s), (6) RRU(s), AND (2) 2.00" HYBRID TRUNK 6/24 4AWG 60M CABLE(s)	C-001	OVERALL SITE PLAN	0	04/14/25	JMB
		GROUND SCOPE: INSTALL (1) CONCRETE PAD, (1) CANOPY, (1) ICE BRIDGE, (1) GPS ANTENNA, UNISTRUT(s), (1) GENERATOR, (1) ATS, (1) PPC,	C-101	DETAILED SITE PLAN	0	04/14/25	JMB
			C-102	DETAILED EQUIPMENT PLAN	0	04/14/25	JMB
		(1) AAV CABINET, (4) LED WORK LIGHT(s), (1) LIGHT SWITCH/TIMER, (1) ENCLOSURE 6160 CABINET, AND (1) B160	C-201	TOWER ELEVATION	0	04/14/25	JMB
RHODE ISLAND STATE BUILDING CODE 2021 RHODE ISLAND STATE ONE AND TWO FAMILY		BATTERY CABINET	C-401	ANTENNA INFORMATION & SCHEDULE	0	04/14/25	JMB
DWELLINGS (IRC 2018 W/ AMND) STATE FUEL GAS CODE (IFGC 2018 W/ AMND)		PROJECT NOTES C-5 1. THE FACILITY IS UNMANNED. C-5 2. A TECHNICIAN WILL VISIT THE SITE APPROXIMATELY ONCE A MONTH FOR ROUTINE INSPECTION AND MAINTENANCE. C-5 3. THE PROJECT WILL NOT RESULT IN ANY SIGNIFICANT LAND C-5		MOUNT DETAILS	0	04/14/25	JMB
2021 RHODE ISLAND PROPERTY MAINTENANCE CODE (IPMC 2018 W/ AMND)				CONSTRUCTION DETAILS	0	04/14/25	JMB
	PROJECT TEAM			CONSTRUCTION DETAILS	0	04/14/25	JMB
-	TOWER OWNER: APPLICANT:			CONSTRUCTION DETAILS	0	04/14/25	JMB
	AMERICAN TOWER T-MOBILE	DISTURBANCE OR EFFECT OF STORM WATER DRAINAGE	E-101	GROUNDING PLAN AND NOTES	0	04/14/25	JMB
	10 PRESIDENTIAL WAY IS REQUIRED. WOBURN. MA 01801 5. HANDICAP ACCESS IS NOT REQUIRED.		E-501	GROUNDING DETAILS	0	04/14/25	JMB
	ENGINEER:	6. THE PROJECT DEPICTED IN THESE PLANS QUALIFIES AS AN ELIGIBLE FACILITIES REQUEST ENTITLED TO EXPEDITED	E-601	PANEL SCHEDULE & ONE-LINE DIAGRAM	0	04/14/25	JMB
	AMERICAN TOWERS LLC	REVIEW UNDER 47 U.S.C. § 1455(A) AS A MODIFICATION OF AN EXISTING WIRELESS TOWER THAT INVOLVES THE		SUPPLEMENTAL SHEETS (12 PAGES)			
UTILITY COMPANIES	1 FENTON MAIN, STE 300 COLLOCATION, REMOVAL, AND/OR REPLACEMENT OF						
POWER COMPANY: NARRAGANSETT ELECTRIC COMPANY PHONE: (800) 322-3223	PROPERTY OWNER: TOWN OF COVENTRY	PROJECT LOCATION DIRECTIONS					
TELEPHONE COMPANY: N/A PHONE: (000) 000-0000	DMPANY: N/A 160 FLAT RIVER ROAD						
Know whate below. Call before you dig.		HEAD EAST ON I-95 NTAKE EXIT 6A FOR HOPKINS HILL RD0.4 MITURN LEFT ONTO HOPKINS HILL RD2.3 MITURN RIGHT ONTO S MAIN ST387 FTTURN RIGHT ONTO RATHBUN ST0.2 MITURN RIGHT ONTO WOOD STDESTINATION WILL BE ON THE LEFT262 FT					

AMERICAN TOWER®
AMERICAN TOWERS LLC
1 FENTON MAIN SUITE 300
CARY, NC 27511 PHONE: (919) 468-0112
PE.0008090-COA
THE USE AND PUBLICATION OF THESE DRAWINGS SHALL BE RESTRICTED TO THE ORIGINAL SITE FOR WHICH THEY ARE PREPARED. ANY USE OR DISCLOSURE OTHER THAN THAT WHICH RELATES TO AMERICAN TOWER OR THE SPECIFIED CARRIER IS STRICTLY PROHIBITED. NEITHER THE ARCHITECT NOR THE ENGINEER WILL BE PROVIDING ON-SITE CONSTRUCTION REVIEW OF THIS PROJECT. CONTRACTOR(S) MUST VERIFY ALL DIMENSIONS AND ADVISE AMERICAN TOWER OR THE SPECIFIED CARRIER OF ANY DISCREPANCIES. ANY PRIOR ISSUANCE OF THIS DRAWING IS SUPERSEDED BY THE LATEST VERSION.
REV. DESCRIPTION BY DATE
FOR CONSTRUCTION JMB 04/14/25
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ATC SITE NUMBER:
415799
ATC SITE NAME:
COVENTRY SPRING LAKE RI
T-MOBILE SITE NAME:
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SITE ADDRESS:
60 WOOD STREET COVENTRY, RI 02816
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CUST. ID: 4PR0700A
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GENERAL CONSTRUCTION NOTES:

- OWNER FURNISHED MATERIALS, T-MOBILE "THE COMPANY" WILL PROVIDE AND THE CONTRACTOR WILL INSTALL
- A. BTS EQUIPMENT FRAME (PLATFORM) AND ICEBRIDGE SHELTER (GROUND BUILD/CO-LOCATE ONLY)
- AC/TELCO INTERFACE BOX (PPC)
- C. ICE BRIDGE (CABLE TRAY WITH COVER) (GROUND BUILD/CO-LOCATE ONLY, GC TO FURNISH AND INSTALL FOR ROOFTOP INSTALLATION)
- D. TOWERS, MONOPOLES TOWER LIGHTING
- GENERATORS & LIQUID PROPANE TANK
- G. ANTENNA STANDARD BRACKETS, FRAMES AND PIPES FOR MOUNTING
- ANTENNAS (INSTALLED BY OTHERS)
- TRANSMISSION LINE
- TRANSMISSION LINE JUMPERS TRANSMISSION LINE CONNECTORS WITH WEATHERPROOFING KITS
- TRANSMISSION LINE GROUND KITS
- HANGERS HOISTING GRIPS
- O. BTS EQUIPMENT
- 2 THE CONTRACTOR IS RESPONSIBLE TO PROVIDE ALL OTHER MATERIALS FOR THE COMPLETE INSTALLATION OF THE SITE INCLUDING, BUT NOT LIMITED TO, SUCH MATERIALS AS FENCING, STRUCTURAL STEEL SUPPORTING SUB-FRAME FOR PLATFORM, ROOFING LABOR AND MATERIALS, GROUNDING RINGS, GROUNDING WIRES COPPER-CLAD OR XIT CHEMICAL GROUND ROD(S), BUSS BARS, TRANSFORMERS AND DISCONNECT SWITCHES WHERE APPLICABLE, TEMPORARY ELECTRICAL POWER CONDUIT, LANDSCAPING COMPOUND STONE, CRANES, CORE DRILLING, SLEEPERS AND RUBBER MATTING, REBAR, CONCRETE CAISSONS, PADS AND/OR AUGER MOUNTS, MISCELLANEOUS FASTENERS, CABLE TRAYS, NON-STANDARD ANTENNA FRAMES AND ALL OTHER MATERIAL AND LABOR REQUIRED TO COMPLETE THE JOB ACCORDING TO THE DRAWINGS AND SPECIFICATIONS. IT IS THE POSITION OF T-MOBILE TO APPLY FOR PERMITTING AND CONTRACTOR RESPONSIBLE FOR PICKUP AND PAYMENT OF REQUIRED PERMITS
- ALL WORK SHALL CONFORM TO ALL CURRENT APPLICABLE FEDERAL, STATE, AND LOCAL CODES, INCLUDING ANSI/EIA/TIA-222, AND COMPLY WITH ATC CONSTRUCTION SPECIFICATIONS
- CONTRACTOR SHALL CONTACT LOCAL 811 FOR IDENTIFICATION OF UNDERGROUND UTILITIES PRIOR TO START OF CONSTRUCTION.
- CONTRACTOR SHALL BE RESPONSIBLE FOR COORDINATING ALL REQUIRED INSPECTIONS.
- ALL DIMENSIONS TO, OF, AND ON EXISTING BUILDINGS, DRAINAGE STRUCTURES, AND SITE IMPROVEMENTS SHALL BE VERIFIED IN FIELD BY CONTRACTOR WITH ALL DISCREPANCIES REPORTED TO THE ENGINEER.
- DO NOT CHANGE SIZE OR SPACING OF STRUCTURAL ELEMENTS 7
- 8 DETAILS SHOWN ARE TYPICAL: SIMILAR DETAILS APPLY TO SIMILAR CONDITIONS UNLESS HERWISE NOTED.
- 9. THESE DRAWINGS DO NOT INCLUDE NECESSARY COMPONENTS FOR CONSTRUCTION SAFETY WHICH SHALL BE THE SOLE RESPONSIBILITY OF THE CONTRACTOR
- CONTRACTOR SHALL BRACE STRUCTURES UNTIL ALL STRUCTURAL ELEMENTS NEEDED 10. FOR STABILITY ARE INSTALLED. THESE ELEMENTS ARE AS FOLLOWS: LATERAL BRACING, 34. ANCHOR BOLTS, ETC.
- CONTRACTOR SHALL DETERMINE EXACT LOCATION OF EXISTING UTILITIES. GROUNDS 11. DRAINS, DRAIN PIPES, VENTS, ETC, BEFORE COMMENCING WORK
- INCORRECTLY FABRICATED, DAMAGED, OR OTHERWISE MISFITTING OR NONCONFORMING MATERIALS OR CONDITIONS SHALL BE REPORTED TO THE T-MOBILE 12. REP PRIOR TO REMEDIAL OR CORRECTIVE ACTION, ANY SUCH REMEDIAL ACTION SHALL REQUIRE WRITTEN APPROVAL BY THE T-MOBILE REP PRIOR TO PROCEEDING.
- EACH CONTRACTOR SHALL COOPERATE WITH THE T-MOBILE REP, AND COORDINATE HIS 13. WORK WITH THE WORK OF OTHERS.
- CONTRACTOR SHALL REPAIR ANY DAMAGE CAUSED BY CONSTRUCTION OF THIS 14. PROJECT TO MATCH EXISTING PRE-CONSTRUCTION CONDITIONS TO THE SATISFACTION OF THE T-MOBILE CONSTRUCTION MANAGER
- ALL CABLE/CONDUIT ENTRY/EXIT PORTS SHALL BE WEATHERPROOFED DURING 15. INSTALLATION USING A SILICONE SEALANT
- WHERE EXISTING CONDITIONS DO NOT MATCH THOSE SHOWN IN THIS PLAN SET. 16. CONTRACTOR SHALL NOTIFY THE T-MOBILE REP AND ENGINEER OF RECORD IMMEDIATELY
- CONTRACTOR SHALL ENSURE ALL SUBCONTRACTORS ARE PROVIDED WITH A COMPLETE 17. AND CURRENT SET OF DRAWINGS AND SPECIFICATIONS FOR THIS PROJECT.
- 18. CONTRACTOR SHALL REMOVE ALL RUBBISH AND DEBRIS FROM THE SITE AT THE END OF EACH DAY
- CONTRACTOR SHALL COORDINATE WORK SCHEDULE WITH AMERICAN TOWER 19. CORPORATION (ATC) AND TAKE PRECAUTIONS TO MINIMIZE IMPACT AND DISRUPTION OF OTHER OCCUPANTS OF THE FACILITY.
- CONTRACTOR SHALL FURNISH T-MOBILE AND AMERICAN TOWER CORPORATION (ATC) 20. WITH A PDF MARKED UP AS-BUILT SET OF DRAWINGS UPON COMPLETION OF WORH
- 21. PRIOR TO SUBMISSION OF BID. CONTRACTOR SHALL COORDINATE WITH T-MOBILE. REP. TO DETERMINE WHAT, IF ANY, ITEMS WILL BE PROVIDED. ALL ITEMS NOT PROVIDED SHALL BE PROVIDED AND INSTALLED BY THE CONTRACTOR. CONTRACTOR WILL INSTALL ALL ITEMS PROVIDED.

- 22. PRIOR TO SUBMISSION OF BID. CONTRACTOR SHALL COORDINATE WITH T-MOBILE REP TO DETERMINE IF ANY PERMITS WILL BE OBTAINED BY CONTRACTOR. ALL REQUIRED PERMITS NOT OBTAINED BY T-MOBILE MUST BE OBTAINED, AND PAID FOR, BY THE CONTRACTOR
- CONTRACTOR SHALL INSTALL ALL SITE SIGNAGE IN ACCORDANCE WITH T-MOBILE 23. SPECIFICATIONS AND REQUIREMENTS.
- CONTRACTOR SHALL SUBMIT ALL SHOP DRAWINGS TO T-MOBILE FOR REVIEW AND 24. APPROVAL PRIOR TO FABRICATION
- ALL EQUIPMENT SHALL BE INSTALLED ACCORDING TO MANUFACTURER'S SPECIFICATIONS AND LOCATED ACCORDING TO T-MOBILE SPECIFICATIONS, AND AS SHOWN IN THESE PLANS
- 26. THE CONTRACTOR SHALL SUPERVISE AND DIRECT THE PROJECT DESCRIBED HEREIN THE CONTRACTOR SHALL BE SOLELY RESPONSIBLE FOR ALL THE CONSTRUCTION MEANS, METHODS, TECHNIQUES, SEQUENCES AND PROCEDURES AND FOR COORDINATING ALL PORTIONS OF THE WORK UNDER THE CONTRACT.
- CONTRACTOR SHALL NOTIFY T-MOBILE REP A MINIMUM OF 48 HOURS IN ADVANCE OF POURING CONCRETE OR BACKFILLING ANY UNDERGROUND UTILITIES, FOUNDATIONS OR SEALING ANY WALL, FLOOR OR ROOF PENETRATIONS FOR ENGINEERING REVIEW AND
- 28. WHEN THE PROJECT SCOPE REQUIRES THE USE OF THE SAFETY CLIMB, THE GENERAL CONTRACTOR SHALL ENSURE THE SAFETY CLIMB IS FREE OF OBSTRUCTIONS, NOT RUBBING ON OR TRAPPED BY ANY INSTALLED CUSTOMER EQUIPMENT. IS VISUALLY AUT, MEETS MANUFACTURER INSTALLATION SPECIFICATIONS, AND IS FIRMLY SECURED AT ALL CABLE GUIDE LOCATIONS UPON PROJECT COMPLETION
- COMPLETION OF PROJECT SHALL NOT OBSTRUCT TRAP LOOSEN OR OTHERWISE CAUSE FAILURE TO MEET MANUFACTURER INSTALLATION REQUIREMENTS FOR THE SAFETY CLIMB

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- CONTRACTOR SHALL BE RESPONSIBLE FOR SITE SAFETY INCLUDING COMPLIANCE WITH ALL APPLICABLE OSHA STANDARDS AND RECOMMENDATIONS AND SHALL PROVIDE ALL NECESSARY SAFETY DEVICES INCLUDING PPE AND PPM AND CONSTRUCTION DEVICES SUCH AS WELDING AND FIRE PREVENTION, TEMPORARY SHORING, SCAFFOLDING TRENCH BOXES/SLOPING, BARRIERS, ETC.
- THE CONTRACTOR SHALL PROTECT AT HIS OWN EXPENSE, ALL EXISTING FACILITIES AND SUCH OF HIS NEW WORK LIABLE TO INJURY DURING THE CONSTRUCTION PERIOD. ANY DAMAGE CAUSED BY NEGLECT ON THE PART OF THIS CONTRACTOR OR HIS REPRESENTATIVES, OR BY THE ELEMENTS DUE TO NEGLECT ON THE PART OF THIS CONTRACTOR OR HIS REPRESENTATIVES, EITHER TO THE EXISTING WORK, OR TO HIS WORK OR THE WORK OF ANY OTHER CONTRACTOR, SHALL BE REPAIRED AT HIS EXPENSE TO THE OWNER'S SATISFACTION.
- ALL WORK SHALL BE INSTALLED IN A FIRST CLASS, NEAT AND WORKMANLIKE MANNER BY MECHANICS SKILLED IN THE TRADE INVOLVED. THE QUALITY OF WORKMANSHIP SHALL BE SUBJECT TO THE APPROVAL OF THE T-MOBILE REP. ANY WORK FOUND BY THE T-MOBILE REP TO BE OF INFERIOR QUALITY AND/OR WORKMANSHIF REPLACED AND/OR REWORKED AT CONTRACTOR EXPENSE UNTIL APPROVAL IS OBTAINED
- IN ORDER TO ESTABLISH STANDARDS OF QUALITY AND PERFORMANCE, ALL TYPES OF MATERIALS LISTED HEREINAFTER BY MANUFACTURER'S NAMES AND/OR 33. MANUFACTURER'S CATALOG NUMBER SHALL BE PROVIDED BY THESE MANUFACTURERS AS SPECIFIED
 - T-MOBILE FURNISHED EQUIPMENT SHALL BE PICKED-UP AT THE T-MOBILE WAREHOUSE NO LATER THAN 48HR AFTER BEING NOTIFIED INSURED, STORED, UNCRATE, PROTECTED AND INSTALLED BY THE CONTRACTOR WITH ALL APPURTENANCES REQUIRED TO PLACE HE EQUIPMENT IN OPERATION, READY FOR USE. THE CONTRACTOR SHALL BE RESPONSIBLE FOR THE EQUIPMENT AFTER PICKING IT UP
- T-MOBILE OR HIS ARCHITECT/ENGINEER RESERVES THE RIGHT TO REJECT ANY 35. EQUIPMENT OR MATERIALS WHICH, IN HIS OWN OPINION ARE NOT IN COMPLIANCE WITH THE CONTRACT DOCUMENTS, EITHER BEFORE OR AFTER INSTALLATION AND THE EQUIPMENT SHALL BE REPLACED WITH EQUIPMENT CONFORMING TO THE REQUIREMENTS OF THE CONTRACT DOCUMENTS BY THE CONTRACTOR AT NO COST TO T-MOBILE OR THEIR ARCHITECT/ENGINEER.

STRUCTURAL STEEL NOTES:

- STRUCTURAL STEEL SHALL CONFORM TO THE LATEST EDITION OF THE AISC. SPECIFICATION FOR THE DESIGN, FABRICATION AND ERECTION OF STRUCTURAL STEEL FOR BUILDINGS."
- 2. STRUCTURAL STEEL ROLLED SHAPES, PLATES AND BARS SHALL CONFORM TO THE FOLLOWING ASTM DESIGNATIONS:
 - A. ASTM A-572, GRADE 50 ALL W SHAPES, UNLESS NOTED OR A992 OTHERWISE
 - B. ASTM A-36 ALL OTHER ROLLED SHAPES, PLATES AND BARS UNLESS NOTED OTHERWISE.
 - C. ASTM A-500, GRADE B HSS SECTION (SQUARE, RECTANGULAR, AND ROUND)
 - D. ASTM A-325, TYPE SC OR N ALL BOLTS FOR CONNECTING STRUCTURAL
 - E. ASTM F-1554 07 ALL ANCHOR BOLTS, UNLESS NOTED OTHERWISE
- ALL EXPOSED STRUCTURAL STEEL MEMBERS SHALL BE HOT-DIPPED GALVANIZED AFTER 3. FABRICATION PER ASTM A123. EXPOSED STEEL HARDWARE AND ANCHOR BOLTS SHALL BE GALVANIZED PER ASTM A153 OR B695.
- ALL FIELD CUT SURFACES, FIELD DRILLED HOLES AND GROUND SURFACES WHERE EXISTING PAINT OR GALVANIZATION REMOVAL WAS REQUIRED SHALL BE REPAIRED WITH (2) BRUSHED COATS OF ZRC GALVILITE COLD GALVANIZING COMPOUND PER ASTM A780 AND MANUFACTURER'S RECOMMENDATIONS

- DO NOT DRILL HOLES THROUGH STRUCTURAL STEEL MEMBERS EXCEPT AS SHOWN AND DETAILED ON STRUCTURAL DRAWINGS.
- 6 CONNECTIONS
 - A. ALL WELDING TO BE PERFORMED BY AWS CERTIFIED WELDERS AND CONDUCTED IN ACCORDANCE WITH THE LATEST EDITION OF THE AWS WELDING CODE D1.1
 - B. ALL WELDS SHALL BE INSPECTED VISUALLY, 25% OF WELDS SHALL BE INSPECTED WITH DYE PENETRANT OR MAGNETIC PARTICLE TO MEET THE ACCEPTANCE CRITERIA OF AWS D1.1. REPAIR ALL WELDS AS NECESSARY
 - INSPECTION SHALL BE PERFORMED BY AN AWS CERTIFIED WELD INSPECTOR.
 - D. IT IS THE CONTRACTORS RESPONSIBILITY TO PROVIDE BURNING/WELDING PERMITS AS REQUIRED BY LOCAL GOVERNING AUTHORITY AND IF REQUIRED SHALL HAVE FIRE DEPARTMENT DETAIL FOR ANY WELDING ACTIVITY
 - E. ALL ELECTRODES TO BE LOW HYDROGEN, MATCHING FILLER METAL, PER AWS D1.1. UNLESS NOTED OTHERWISE.
 - F. MINIMUM WELD SIZE TO BE 0.1875 INCH FILLET WELDS, UNLESS NOTED
 - G. PRIOR TO FIELD WELDING GALVANIZING MATERIAL, CONTRACTOR SHALL GRIND OFF GALVANIZING 1/2" BEYOND ALL FIELD WELD SURFACES. AFTER WELD AND WELD INSPECTION IS COMPLETE, REPAIR ALL GROUND AND WELDED SURFACES WITH ZRC GALVILITE COLD GALVANIZING COMPOUND PER ASTM A780 AND MANUFACTURERS RECOMMENDATIONS.
 - H THE CONTRACTOR SHALL PROVIDE ADEQUATE SHORING AND/OR BRACING WHERE REQUIRED DURING CONSTRUCTION UNTIL ALL CONNECTIONS ARE COMPLETE
 - ANY FIELD CHANGES OR SUBSTITUTIONS SHALL HAVE PRIOR APPROVAL FROM 13 1 THE ENGINEER, AND T-MOBILE PROJECT MANAGER IN WRITING

ANTENNA INSTALLATION NOTES:

- WORK INCLUDED
 - ANTENNA AND COAXIAL CABLES ARE FURNISHED BY T-MOBILE UNDER A SEPARATE CONTRACT. THE CONTRACTOR SHALL ASSIST ANTENNA Α. INSTALLATION CONTRACTOR IN TERMS OF COORDINATION AND SITE ACCESS. 16. ERECTION SUBCONTRACTOR SHALL BE RESPONSIBLE FOR THE PROTECTION OF PERSONNEL
 - B. INSTALL ANTENNAS AS INDICATED ON DRAWINGS AND T-MOBILE SPECIFICATIONS
 - C. INSTALL GALVANIZED STEEL ANTENNA MOUNTS AS INDICATED ON DRAWINGS.
 - D. INSTALL FURNISHED GALVANIZED STEEL OR ALUMINUM WAVEGUIDE AND PROVIDE PRINTOUT OF THAT TEST
 - E. CONTRACTOR SHALL PROVIDE FOUR (4) SETS OF SWEEP TESTS USING ANRITZU-PACKARD 8713B RF SCALAR NETWORK ANALYZER. SUBMIT FREQUENCY DOMAIN REFLECTOMETER(FDR) TESTS RESULTS TO THE PROJECT MANAGER. SWEEP TESTS SHALL BE AS PER ATTACHED RES "MINIMUM FIELD TESTING RECOMMENDED FOR ANTENNA AND HELIAX COAXIAL CABLE SYSTEMS" DATED 10/5/93. TESTING SHALL BE PERFORMED BY AN INDEPENDENT TESTING SERVICE 20. AND BE BOUND AND SUBMITTED WITHIN ONE WEEK OF WORK COMPLETION. 21
 - F. INSTALL COAXIAL CABLES AND TERMINATING BETWEEN ANTENNAS AND EQUIPMENT PER MANUFACTURER'S RECOMMENDATIONS. WEATHERPROOF ALL CONNECTIONS BETWEEN THE ANTENNA AND EQUIPMENT PER MANUFACTURER'S REQUIREMENTS. TERMINATE ALL COAXIAL CABLE THREE (3) FEET IN EXCESS OF ENTRY PORT LOCATION UNLESS OTHERWISE STATED.
- G. ANTENNA AND COAXIAL CABLE GROUNDING:
- 2. ALL EXTERIOR #6 GREEN GROUND WIRE "DAISY CHAIN" CONNECTIONS ARE TO BE WEATHER SEALED WITH RES CONNECTORS/SPLICE WEATHERPROOFING KIT #221213 OR
- ALL COAXIAL CABLE GROUNDING KITS ARE TO BE INSTALLED ON STRAIGHT RUNS OF 3. COAXIAL CABLE (NOT WITHIN BENDS).

CONCRETE AND REINFORCING STEEL NOTES:

- DESIGN AND CONSTRUCTION OF ALL CONCRETE ELEMENTS SHALL CONFORM TO THE LATEST EDITIONS OF ALL APPLICABLE CODES INCLUDING: ACI 301 "SPECIFICATIONS FOR STRUCTURAL CONCRETE FOR BUILDINGS", ACI 117 "SPECIFICATIONS FOR TOLERANCES FOR CONCRETE CONSTRUCTION AND MATERIALS", AND ACI 318 "BUILDING CODE REQUIREMENTS FOR REINFORCED CONCRETE.'
- 2. MIX DESIGN SHALL BE APPROVED BY T-MOBILE REP PRIOR TO PLACING CONCRETE
 - CONCRETE SHALL BE NORMAL WEIGHT, 6 % AIR ENTRAINED (+/- 1,5%) WITH A SLUME RANGE OF 3-6" AND HAVE A MINIMUM 28-DAY COMPRESSIVE STRENGTH OF 4500 PSI UNLESS OTHERWISE NOTED.
- THE FOLLOWING MATERIALS SHALL BE USED:
 - PORTLAND CEMENT: ASTM C150, TYPE 2 REINFORCEMENT: ASTM A185. PLAIN STEEL WELDED WIRE FABRIC

- REINFORCEMENT BARS: NORMAL WEIGHT AGGREGATE: WATER: WEI DED WIRE FABRIC: ADMIXTURES: -WATER-REDUCING AGENT: ASTM C 494/C 494M. TYPE A -AIR-ENTERING AGENT: -SUPERPLASTICIZER -RETARDING MINIMUM CONCRETE COVER FOR REINFORCING STEEL SHALL BE NO LESS THAN 3". A 3/4" CHAMEER SHALL BE PROVIDED AT ALL EXPOSED EDGES OF CONCRETE IN ACCORDANCE WITH ACI 301 SECTION 4.2.4, UNLESS NOTED OTHER
- INSTALLATION OF CONCRETE EXPANSION/WEDGE ANCHOR SHALL BE PER APPROVAL FROM AN ATC ENGINEER WHEN DRILLING HOLES IN CONCRETE

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- IN "METHOD 1" OF ACI 301
- DO NOT WELD OR TACK WELD REINFORCING STEEL.
- IN PLACE BEFORE START OF CONCRETE PLACEMENT
- 11.
- 12. DO NOT PLACE CONCRETE IN WATER, ICE, OR ON FROZEN GROUND.
- MATERIALS CONTAINING CHLORIDE, CALCIUM, SALTS, ETC. SHALL NOT BE USED. PROTECT FRESH CONCRETE FROM WEATHER FOR 7 DAYS, MINIMUM.
- 14. ALL CONCRETE SHALL HAVE A "SMOOTH FORM FINISH.
- 15. TENSILE CAPACITY (CLASS A) IN ACCORDANCE WITH ACI 318.
- PRACTICE FOR DETAILING REINFORCED CONCRETE STRUCTURES" (ACI 315)
- CONSTRUCTION JOINTS, UNLESS SHOWN IN THE CONTRACT DRAWINGS
- 18.


GRAVEL BENEATH SLAB.

ELECTRICAL NOTES:

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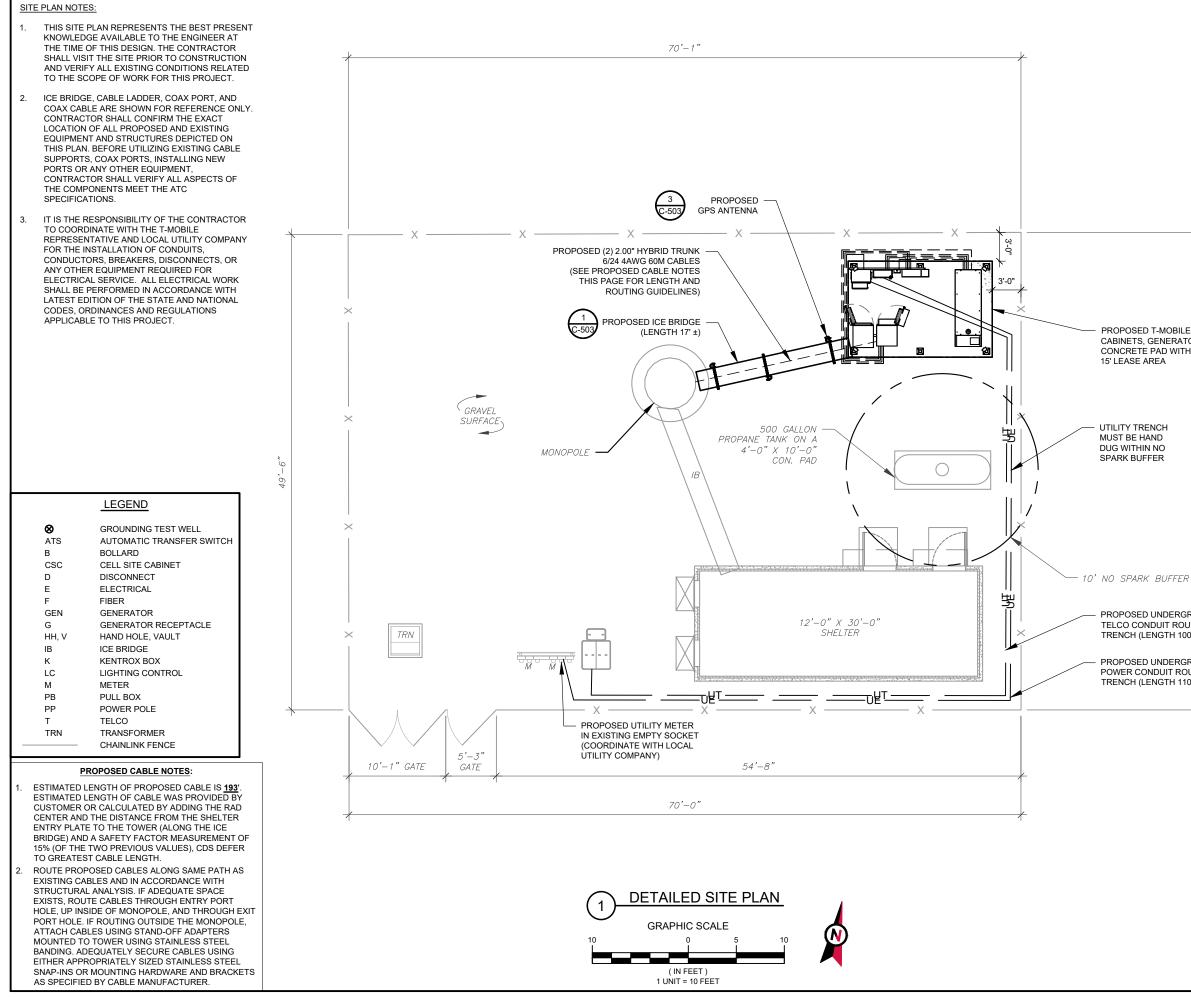
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EXISTING	PROP

	ADJACENT PROPERTY LINE LEASE AREA EASEMENT WOOD FENCE WIRE FENCE METAL FENCE GUARD RAIL CHAINLINK FENCE ROAD (DIRT)
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AMERICAN TOWERS L 1 FENTON MAIN	LC
SUITE 300 CARY, NC 27511	
PHONE: (919) 468-0112	
PE.0008090-COA	
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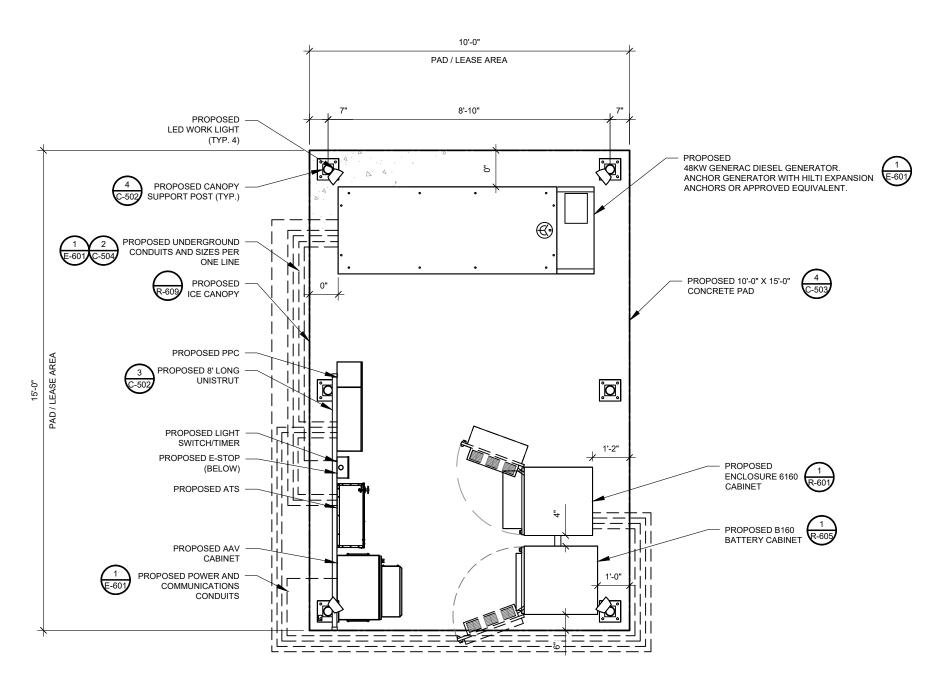



	AMERICAN TOWER® AMERICAN TOWERS LLC 1 FENTON MAIN SUITE 300 CARY, NC 27511 PHONE: (919) 468-0112 PE.0008090-COA	GS FOR ES IER
<u>\</u>	THE USE AND PUBLICATION OF THESE DRAWIN SHALL BE RESTRICTED TO THE ORIGINAL SITE F WHICH THEY ARE PREPARED. ANY USE OR DISCLOSURE OTHER THAN THAT WHICH RELAT TO AMERICAN TOWER OR THE SPECIFIED CARR IS STRICTLY PROHIBITED. NEITHER THE ARCHITE NOR THE ENGINEER WILL BE PROVIDING ON-SI CONSTRUCTION REVIEW OF THIS PROJECT. CONTRACTOR(S) MUST VERIFY ALL DIMENSION AND ADVISE AMERICAN TOWER OR THE SPECIFI CARRIER OF ANY DISCREPANCIES. ANY PRIOF ISSUANCE OF THIS DRAWING IS SUPERSEDED F THE LATEST VERSION.	ECT TE NS IED R
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" 0 0	ATC SITE NUMBER: 415799 ATC SITE NAME: COVENTRY SPRING LAKE R T-MOBILE SITE NAME:	 I
40'	4PR0700A SITE ADDRESS: 60 WOOD STREET COVENTRY, RI 02816 SEAL:	_
ROUND 2 2 $0^{2}\pm$ $0^{2}\pm$ ROUND $1^{2}\pm$ $0^{$	JOSHUA H. WALTON No. 11581 REGISTERED PROFESSIONAL ENGINEER CIVIL	
	Digitally Signed: 2025-04-23	
	ATC PROJ. #: 15132784_D2 CUST. ID: 4PR0700A CUST. #: 4PR0700A DETAILED SITE PLAN	
	SHEET NUMBER: REVIS	ION:

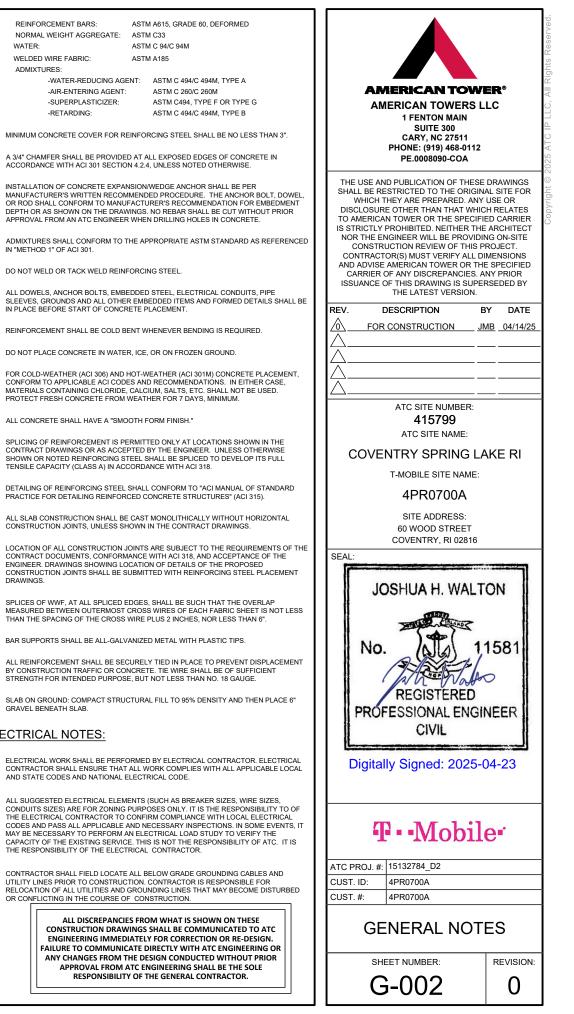SITE PLAN / ELECTRICAL NOTES:

1.


- THIS SITE PLAN REPRESENTS THE BEST PRESENT KNOWLEDGE AVAILABLE TO THE ENGINEER AT THE TIME OF THIS DESIGN. THE CONTRACTOR SHALL VISIT THE SITE PRIOR TO CONSTRUCTION AND VERIFY ALL EXISTING CONDITIONS RELATED TO THE SCOPE OF WORK FOR THIS PROJECT.
- 2. ICE BRIDGE, CABLE LADDER, COAX PORT, AND COAX CABLE ARE SHOWN FOR REFERENCE ONLY. CONTRACTOR SHALL CONFIRM THE EXACT LOCATION OF ALL PROPOSED AND EXISTING EQUIPMENT AND STRUCTURES DEPICTED ON THIS PLAN. BEFORE UTILIZING EXISTING CABLE SUPPORTS, COAX PORTS, INSTALLING NEW PORTS OR ANY OTHER EQUIPMENT, CONTRACTOR SHALL VERIFY ALL ASPECTS OF THE COMPONENTS MEET THE ATC SPECIFICATIONS.
- 3. IT IS THE RESPONSIBILITY OF THE CONTRACTOR TO COORDINATE WITH THE T-MOBILE REPRESENTATIVE AND LOCAL UTILITY COMPANY FOR THE INSTALLATION OF CONDUITS, CONDUCTORS, BREAKERS, DISCONNECTS, OR ANY OTHER EQUIPMENT REQUIRED FOR ELECTRICAL SERVICE. ALL ELECTRICAL WORK SHALL BE PERFORMED IN ACCORDANCE WITH LATEST EDITION OF THE STATE AND NATIONAL CODES, ORDINANCES AND REGULATIONS APPLICABLE TO THIS PROJECT.
- 4. ALL CONDUITS SHALL BE INSTALLED UNDERGROUND AND PER APPLICABLE NEC AND LOCAL REQUIREMENTS UNLESS SHOWN OTHERWISE ON THESE PLANS. ANY CONDUITS INSTALLED ABOVE GRADE SHALL BE SECURED PER NEC 344 (MAX INTERVAL 10') AND THE ENTIRE CONDUIT SHALL BE PAINTED SAFETY/REFLECTIVE YELLOW OR ORANGE TO INCREASE VISIBILITY AND REDUCE TRIP HAZARDS.



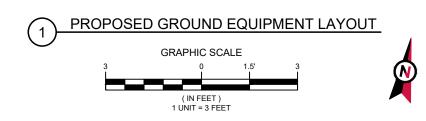

AMERICAN TOW AMERICAN TOWERS L	
1 FENTON MAIN	LC
SUITE 300 CARY, NC 27511	
PHONE: (919) 468-0112 PE.0008090-COA	
PE.0008090-COA	
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COVENTRY SPRING LA	AKE RI
T-MOBILE SITE NAME:	
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PER MOUNT ANALYSIS COMPLETED BY ATC, DATED 03/04/2025, THE PROPOSED MOUNT CAN ADEQUATELY SUPPORT THE PROPOSED


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I	AMERICAN TOWER® AMERICAN TOWERS LLC
I	1 FENTON MAIN SUITE 300
I	CARY, NC 27511 PHONE: (919) 468-0112
	PE.0008090-COA
I	THE USE AND PUBLICATION OF THESE DRAWINGS SHALL BE RESTRICTED TO THE ORIGINAL SITE FOR
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	REV. DESCRIPTION BY DATE
	FOR CONSTRUCTION JMB 04/14/25
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	ATC SITE NUMBER:
	415799
	ATC SITE NAME:
	COVENTRY SPRING LAKE RI
	T-MOBILE SITE NAME:
	4PR0700A
	SITE ADDRESS: 60 WOOD STREET
	COVENTRY, RI 02816
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	ATC PROJ. #: 15132784_D2
	CUST. ID: 4PR0700A
	CUST. #: 4PR0700A
	TOWER ELEVATION
	SHEET NUMBER: REVISION:
	C-201 0

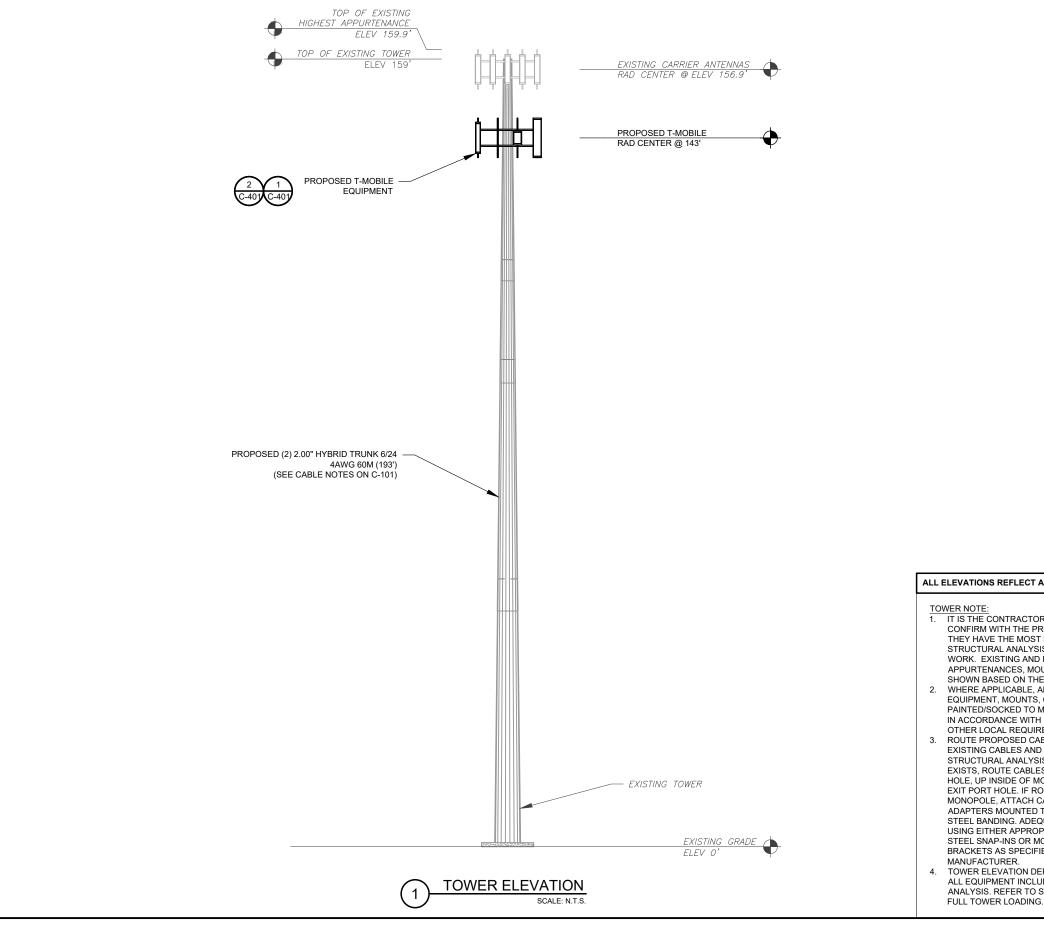ALL ELEVATIONS REFLECT ABOVE GROUND LEVEL (A.G.L.)

1. IT IS THE CONTRACTOR'S RESPONSIBILITY TO CONFIRM WITH THE PROJECT MANAGER THAT THEY HAVE THE MOST RECENT VERSION OF THE STRUCTURAL ANALYSIS BEFORE COMMENCING WORK. EXISTING AND PROPOSED TOWER APPURTENANCES, MOUNTS, AND ANTENNAS ARE SHOWN BASED ON THE STRUCTURAL ANALYSIS. 2. WHERE APPLICABLE, ALL NEW ANTENNAS, EQUIPMENT, MOUNTS, CABLING, ETC. SHALL BE PAINTED/SOCKED TO MATCH EXISTING EQUIPMENT IN ACCORDANCE WITH FAA, JURISDICTION, AND/OR OTHER LOCAL REQUIREMENTS. 3. ROUTE PROPOSED CABLES ALONG SAME PATH AS

EXISTING CABLES AND IN ACCORDANCE WITH STRUCTURAL ANALYSIS. IF ADEQUATE SPACE EXISTS, ROUTE CABLES THROUGH ENTRY PORT HOLE, UP INSIDE OF MONOPOLE, AND THROUGH EXIT PORT HOLE. IF ROUTING OUTSIDE THE MONOPOLE, ATTACH CABLES USING STAND-OFF ADAPTERS MOUNTED TO TOWER USING STAINLESS STEEL BANDING. ADEQUATELY SECURE CABLES USING EITHER APPROPRIATELY SIZED STAINLESS STEEL SNAP-INS OR MOUNTING HARDWARE AND BRACKETS AS SPECIFIED BY CABLE

TOWER ELEVATION DEPICTION MAY NOT REFLECT ALL EQUIPMENT INCLUDED IN STRUCTURAL ANALYSIS. REFER TO STRUCTURAL ANALYSIS FOR

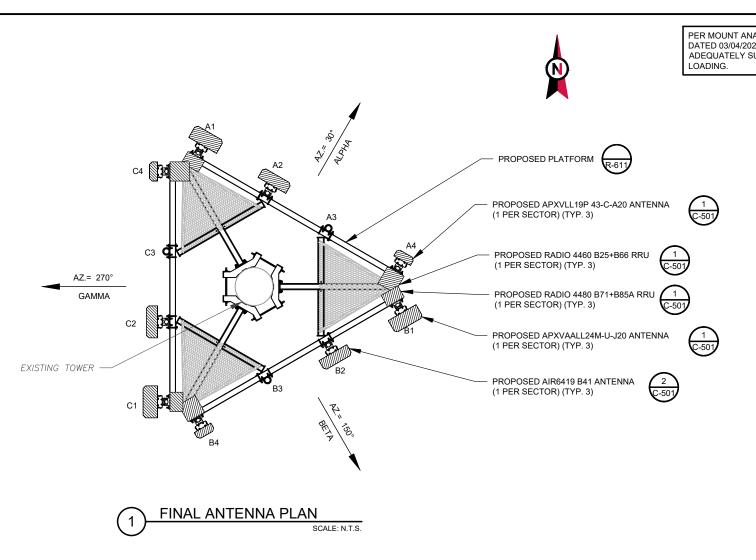


SECTOR	ANT.	MODEL #	RAD CENTER	AZIMUTH	ADDITIONAL TOWER MOUNTED EQUIPMENT	CABLE DESCRIPTION	
	A1	APXVAALL24M-U-J20	- 143'			RADIO 4480 B71+B85	(2) 2.00" HYBRID TRUN 6/24 4AWG 60M (193')
	A2	AIR 6419 B41		30° -	-		
ALPHA –	A3	-			-		
	A4	APXVLL19P_43-C-A20			RADIO 4460 B25+B66		
	B1	APXVAALL24M-U-J20		143' 150°	RADIO 4480 B71+B85		
	B2	AIR 6419 B41			-		
BETA -	В3	-			-		
	B4	APXVLL19P_43-C-A20			RADIO 4460 B25+B66		
	C1	APXVAALL24M-U-J20		270°	270°	RADIO 4480 B71+B85	-
GAMMA	C2	AIR 6419 B41				-	
GAMIMA	C3	-			-		
	C4	APXVLL19P_43-C-A20			RADIO 4460 B25+B66		
GC TO CAP ALL	UNUSED POP	DS MATCHES THE FINAL CONSTRUCTION D RTS. F PROPOSED EQUIP DOES NOT CAUSE TOW				LLING THE EQUIPMENT.	

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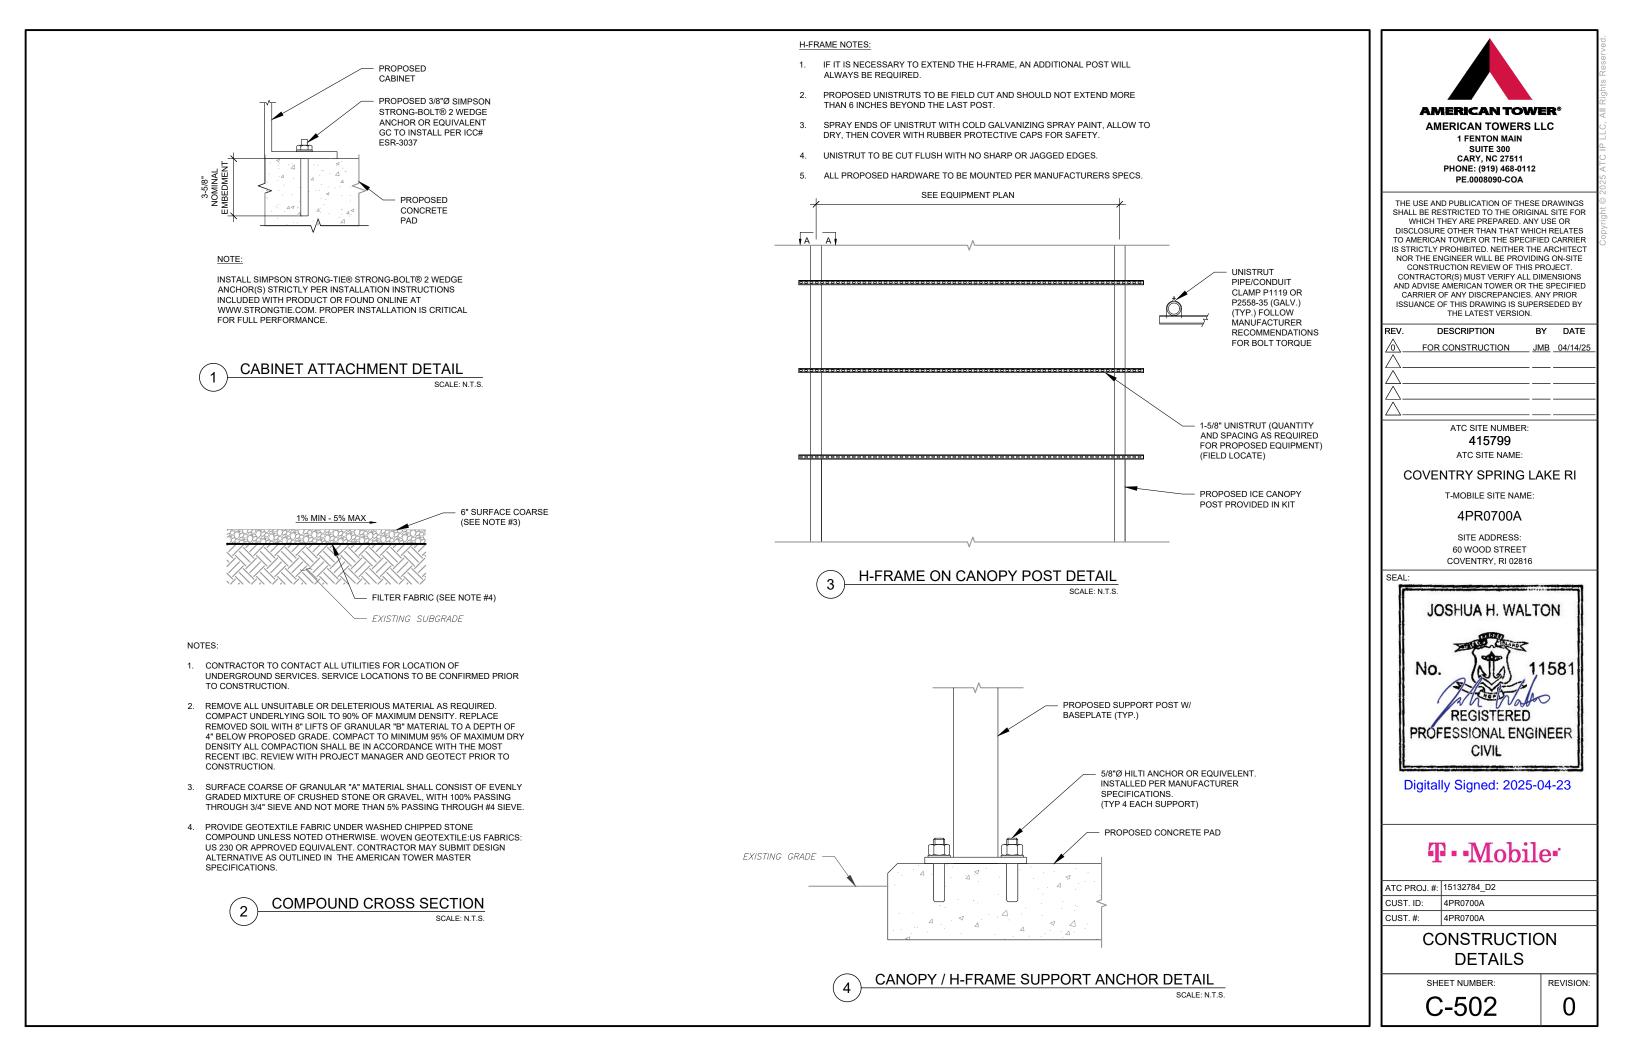
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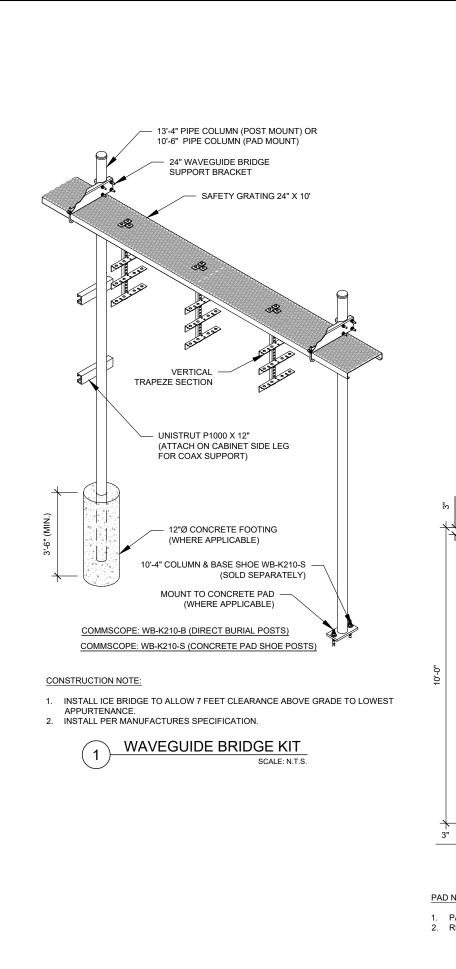
AMERICAN TOW	ER®
AMERICAN TOWERS L	
1 FENTON MAIN SUITE 300	
CARY, NC 27511 PHONE: (919) 468-0112	
PE.0008090-COA	
THE USE AND PUBLICATION OF THESE	DRAWINGS
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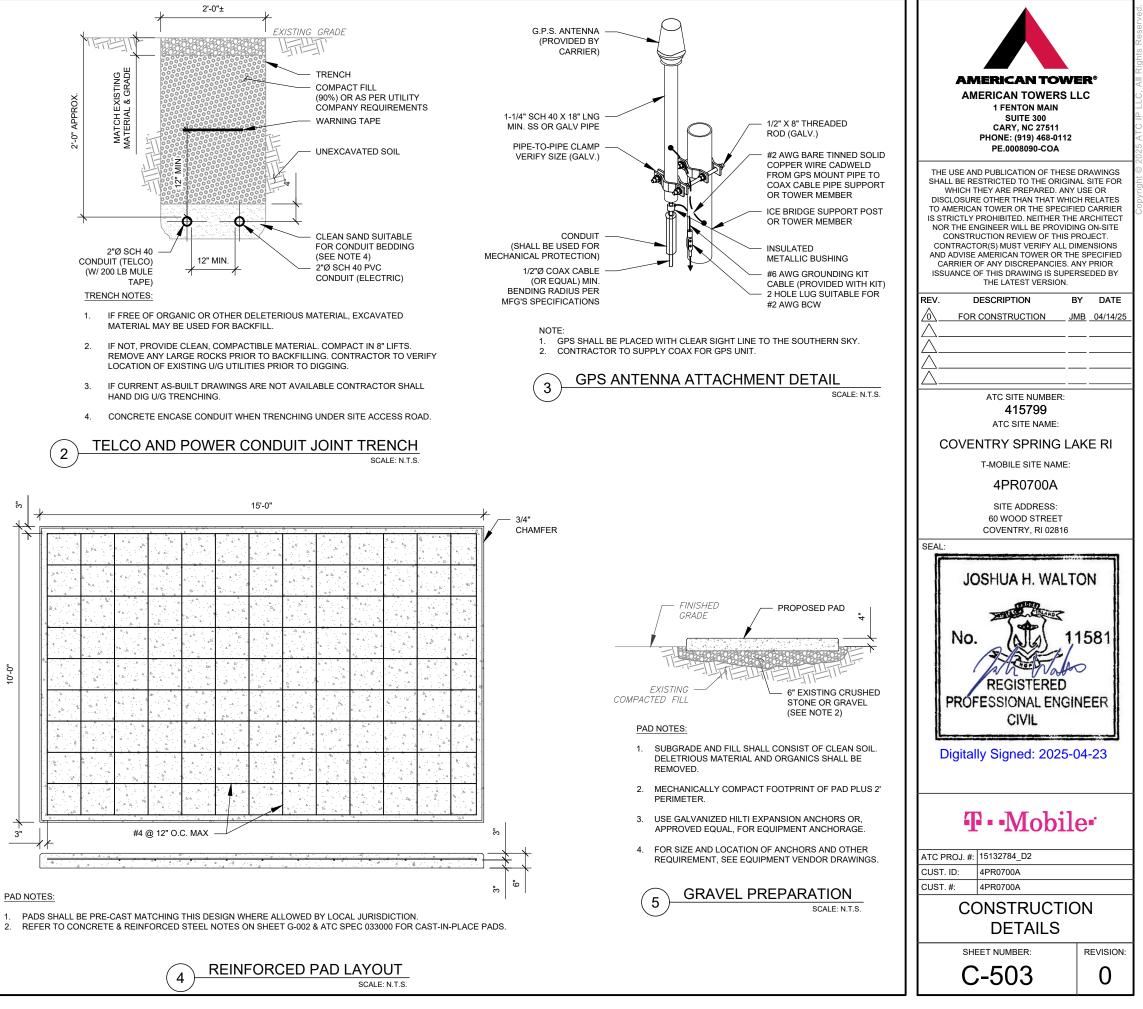
RF JUMPER LENGTH
MONOPOLE = 15'± SELF SUPPORT = FACE WIDTH + 15'
FINAL RFDS FOR TYPE AND QUANTITY




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1 FENTON MAIN SUITE 300			
CARY, NC 27511 PHONE: (919) 468-0112			
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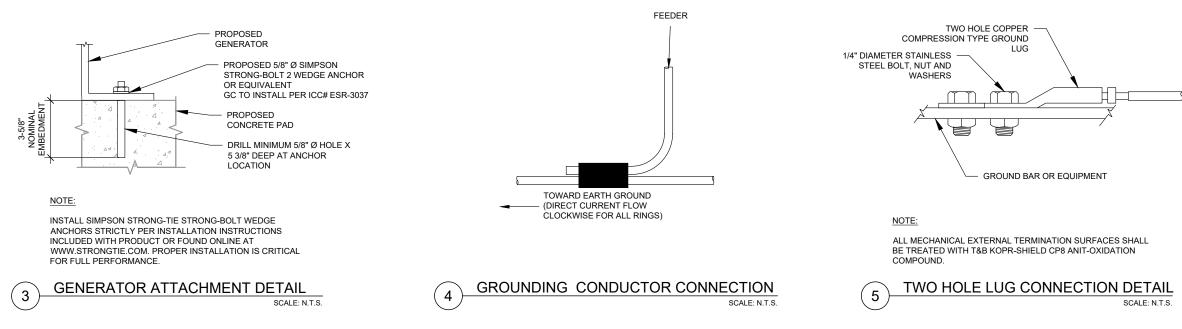


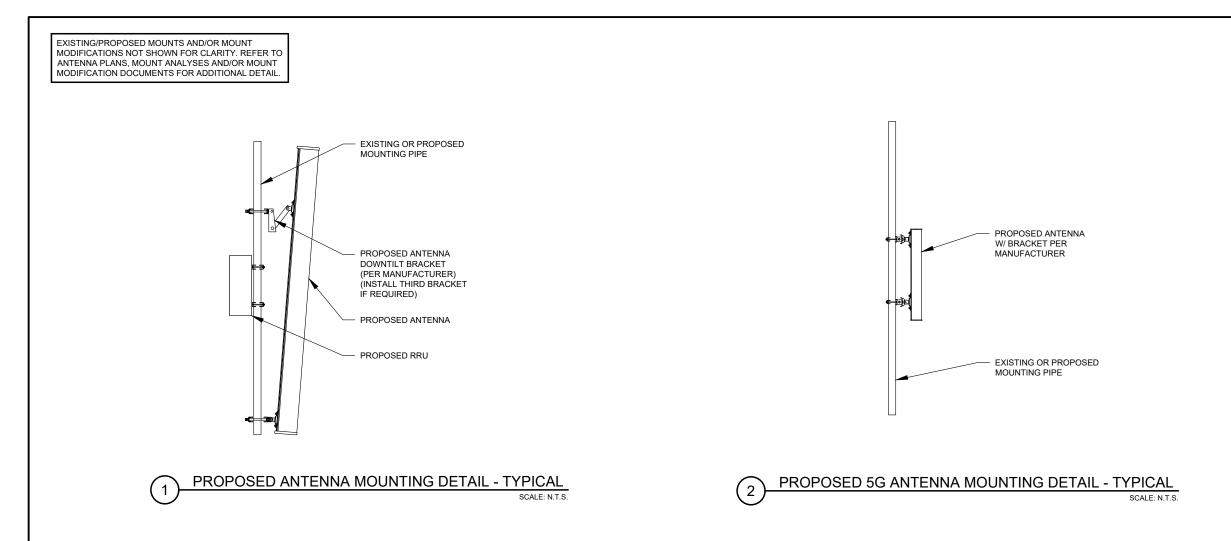


TRENCH NOTES:

- IF FREE OF ORGANIC OR OTHER DELETERIOUS MATERIAL, EXCAVATED 1. MATERIAL MAY BE USED FOR BACKFILL.
- 2. IF NOT, PROVIDE CLEAN, COMPACTIBLE MATERIAL. COMPACT IN 8" LIFTS. REMOVE ANY LARGE ROCKS PRIOR TO BACKFILLING. CONTRACTOR TO VERIFY LOCATION OF EXISTING U/G UTILITIES PRIOR TO DIGGING.
- 3. IF CURRENT AS-BUILT DRAWINGS ARE NOT AVAILABLE CONTRACTOR SHALL HAND DIG U/G TRENCHING.
- 4. CONFIRM SPACING AND DEPTH WITH NEC OR LOCAL CODE REQUIREMENTS
- AC POWER CONDUITS MUST BE 3" MINIMUM FROM OTHER AC CONDUITS AND 12' 5 MINIMUM FROM COMMUNICATIONS CONDUITS

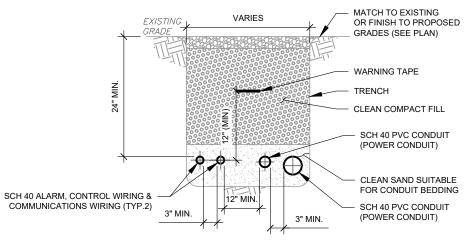GENERATOR SERVICE CONDUIT TRENCH 2 SCALE: N.T.S.



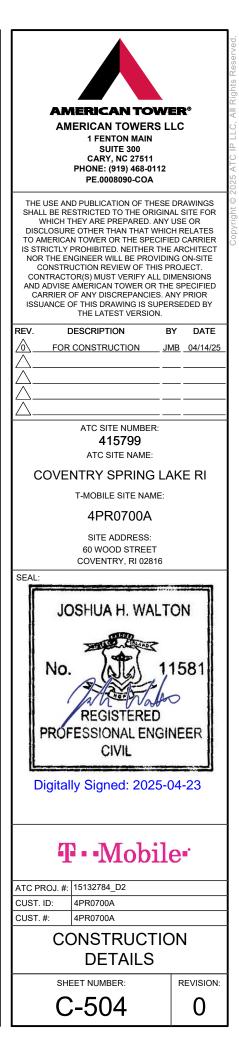


2.

ALL EQUIPMENT ENCLOSURES, DEVICES AND CONDUITS SHALL BE GROUNDED TO CONFORM WITH THE LATEST REQUIREMENTS OF THE NEC BY THE INSTALLATION OF A SEPARATE, GREEN, INSULATED GROUND CONDUCTOR FOR ALL FEEDER AND BRANCH CIRCUITS. GROUND CONDUCTORS SHALL BE OF THE SIZE INDICATED ON THE DRAWINGS. GROUND CONDUCTORS SHALL BE CONTINUOUS IN LENGTH AND SHALL BE BONDED TO EACH ENCLOSURE THEY PASS THROUGH. CONDUIT SHALL NOT BE USED AS A GROUNDING CONDUCTOR.


GROUNDING CONDUCTORS SHALL:

- A. BE #2 AWG SOLID BARE TINNED COPPER (SBTC) FOR ALL GROUNDING SYSTEM WIRE UNLESS OTHERWISE NOTED, OR OTHERWISE REQUIRED BY CODE.
- B. BE MINIMUM 12" BEND RADIUS. KEEP NUMBER OF BENDS TO A MINIMUM.
- C. AVOID LONG BONDING CONNECTION RUNS. MAKE DIRECT AS POSSIBLE.
- D. NOT HAVE ANY U-SHAPED RUNS. BE IN NON-METALLIC CONDUIT ONLY, IF IN CONDUIT.
- F. BE PLACED THROUGH NON-METALLIC SLEEVES IN FLOORS, WALLS, CEILINGS, ETC.
- G. PROTECTED IN NON-METALLIC CONDUIT WHERE EXPOSED ABOVE GRADE
- INSTALL ALL GROUNDING RINGS AND RADIALS WITH CONDUCTIVE CEMENT, SANKOSHA AS DISTRIBUTED BY ELECTRIC MOTION COMPANY, INC., WINSTED, CT 06098, OR AS SPECIFICALLY INDICATED. INSTALL PER MANUFACTURER'S SPECIFICATIONS.
- GROUND RINGS SHALL BE:
 - A. MINIMUM 30" BELOW GRADE, OR BELOW FROST LINE WHICHEVER IS DEEPER
 - B. MINIMUM 2' FROM FOUNDATIONS, FOOTINGS, OTHER GROUNDING SYSTEMS AND ALL CONDUCTIVE OBJECTS.
 - C. WITH MINIMUM 12" BEND RADII. WITH ALL CONNECTIONS IN CONTACT D. WITH EARTH, BONDED BY
 - EXOTHERMIC WELDING. E. BONDED TO A SINGLE POINT GROUND (SPG) WITH A SINGLE WIRE AS INDICATED ON DRAWINGS.
- GROUND RODS SHALL BE:
 - A. MINIMUM 5/8" DIAMETER.
 - MINIMUM 10' LONG. COPPER-CLAD GALVANIZED STEEL OR C.
 - STAINLESS STEEL. PLACED IN UNDISTURBED SOIL AND D.
 - BELOW THE FROST LINE E. INSTALLED WITH MINIMUM SEPARATION DISTANCE OF TWICE THE DEPTH OF
 - THE ROD(S), OR AS INDICATED ON DRAWINGS. F. MINIMUM TWO (2) RODS ON THE
 - TOWER RING OR ONE (1) PER LEG WHICHEVER IS LARGER, MINIMUM FOUR (4) RODS ON EVERY EQUIPMENT BUILDING RING WITH ONE AT EACH CORNER OR AS INDICATED, MINIMUM ONE (1) ROD FOR POWER SERVICE GROUNDING ELECTRODE, AND MINIMUM ONE (1) ROD AT END OF EACH RADIAL
- CONDUCTIVE OBJECTS, SUCH AS FENCES, SHALL BE BONDED TO THE GROUNDING SYSTEM IF WITHIN 20' OF THE TOWER GROUNDING SYSTEM, OR 5' OF ANY OTHER GROUNDED COMPONENT.

5

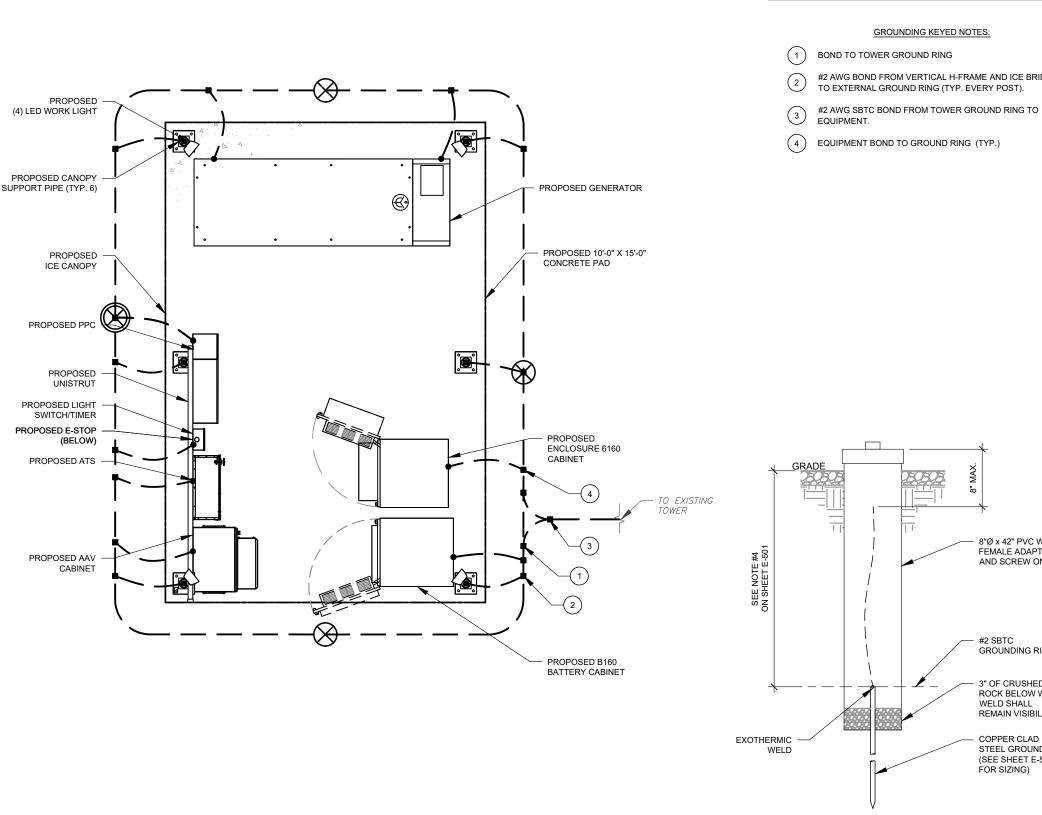

DETAILED GROUNDING PLAN 1 SCALE: N.T.S

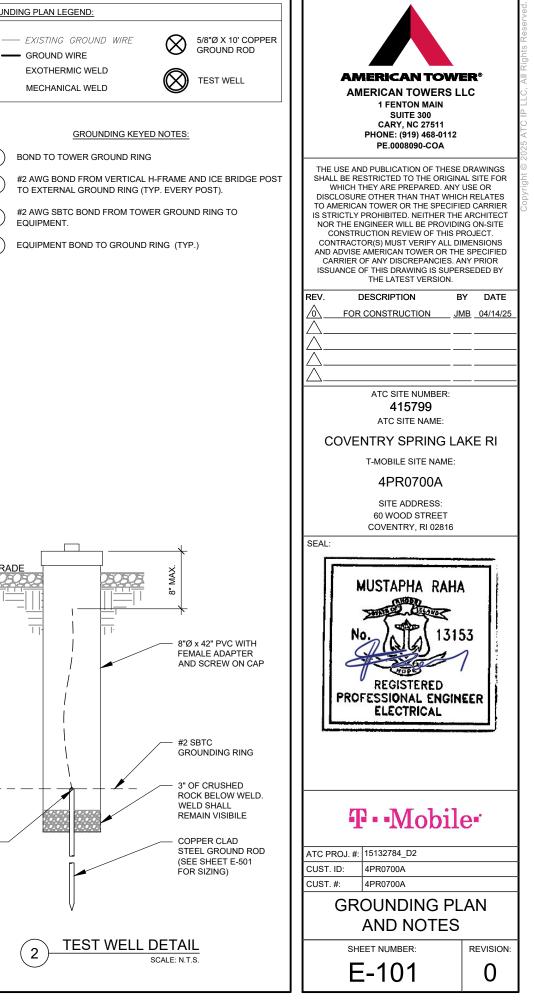


GROUNDING PLAN LEGEND:


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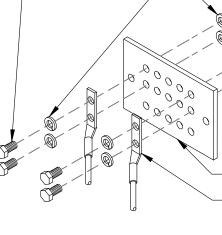
GROUND WIRE

EXOTHERMIC WELD

MECHANICAL WELD



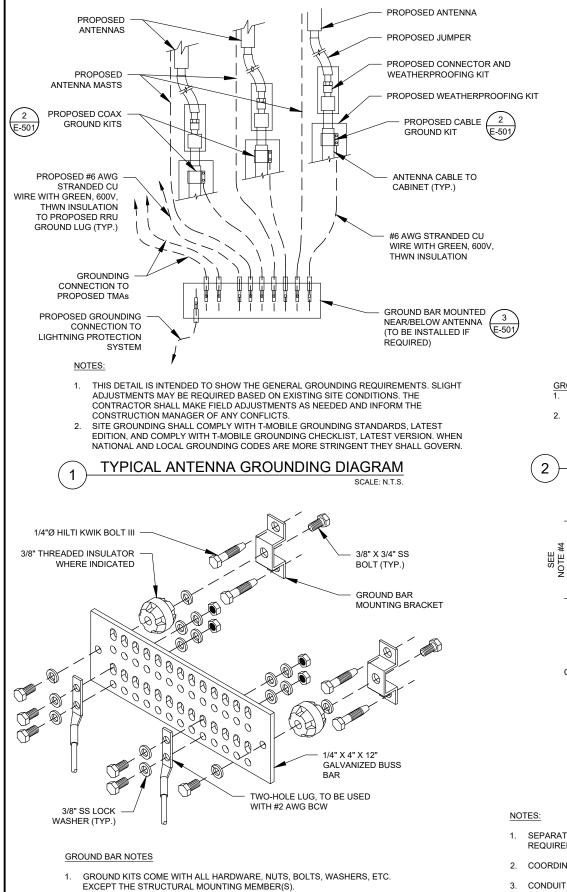

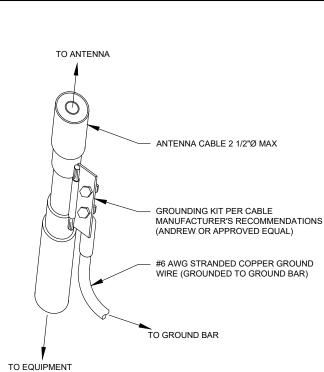

3/8" X 1-1/4" SS BOLT

(EACH SIDE)


GROUND BAR NOTES:

- GROUND BAR KITS COME WITH ALL HAR 1. WASHERS, ETC. EXCEPT THE STRUCTUR
- 2. GROUND BAR TO BE BONDED DIRECTLY

<u>GROUND KIT NOTES:</u> 1. DO NOT INSTALL CABLE GROUND KIT AT A BEND AND ALWAYS DIRECT GROUND WIRE DOWN TO GROUND BAR.

2. CONTRACTOR SHALL PROVIDE WEATHERPROOFING KIT (ANDREW PART NUMBER 221213) AND INSTALL/TAPE PER MANUFACTURER'S SPECIFICATIONS.

CABLE GROUND KIT CONNECTION DETAIL SCALE: N.T.S.

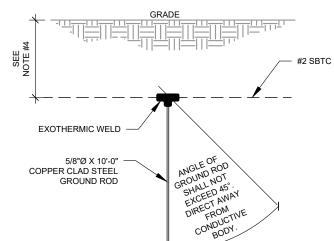

EXOTHERMIC WELD (THERMOWELD OR EQUIVALENT) PÀRALLEL, NO T-WELDS ALLOWED (NO SLAG OR DEFORMITIES ALLOWED)

3

EXTERIOR GROUND RING #2 SBTC GROUNDING CONDUCTOR

6

SEPARATION DIMENSION TO BE VERIFIED WITH LOCAL UTILITY COMPANY REQUIREMENTS

GROUND ROD DETAIL

SCALE: N.T.S.

2. COORDINATE UTILITY, LOCATE BEFORE DIGGING.

5

- CONDUIT TRENCHING DEPTHS AT 36" OR 6" BELOW FROST LINE, 3. WHICHEVER IS GREATER.
- ALL RING AND RADIAL DEPTHS AT 30" OR 6" BELOW FROST LINE, 4. WHICHEVER IS GREATER.


MAIN GROUND BAR DETAIL SCALE: N.T.S.

2. GROUND BAR SHALL BE BOLTED TO STRUCTURAL MEMBER OR

ANCHORED TO CONCRETE SLAB W/ HILTI KWIK BOLT III.

4

/4" SS BOLT DE) /4" SS BOLT (EACH SIDE)	AMERICAN TOWER® AMERICAN TOWERS LLC 1 FENTON MAIN SUITE 300 CARX NO 27544
1/4" X 4" X 6" GROUND BAR (ERICO P/N: EGBA14406CC OR EQUAL) TWO-HOLE LUG, TO BE USED WITH #2 AWG BCW (LOWER TOWER GROUND BAR ONLY)	CARY, NC 27511 PHONE: (919) 468-0112 PE.0008090-COA THE USE AND PUBLICATION OF THESE DRAWINGS SHALL BE RESTRICTED TO THE ORIGINAL SITE FOR WHICH THEY ARE PREPARED. ANY USE OR DISCLOSURE OTHER THAN THAT WHICH RELATES TO AMERICAN TOWER OR THE SPECIFIED CARRIER IS STRICTLY PROHIBITED. NEITHER THE ARCHITECT NOR THE ENGINEER WILL BE PROVIDING ON-SITE CONSTRUCTION REVIEW OF THIS PROJECT. CONTRACTOR(S) MUST VERIFY ALL DIMENSIONS AND ADVISE AMERICAN TOWER OR THE SPECIFIED CARRIER OF ANY DISCREPANCIES. ANY PRIOR ISSUANCE OF THIS DRAWING IS SUPERSEDED BY THE LATEST VERSION.
BAR NOTES:	REV. DESCRIPTION BY DATE Image: boot structure JMB 04/14/25 04/14/25
IND BAR KITS COME WITH ALL HARDWARE, NUTS, BOLTS, IERS, ETC. EXCEPT THE STRUCTURAL MOUNTING MEMBER(S).	<u></u>
ND BAR TO BE BONDED DIRECTLY TO TOWER.	$\bigwedge^{\bigtriangleup}$
	ATC SITE NUMBER: 415799 ATC SITE NAME: COVENTRY SPRING LAKE RI
TOWER GROUND BAR DETAIL SCALE: N.T.S.	T-MOBILE SITE NAME: 4PR0700A SITE ADDRESS: 60 WOOD STREET COVENTRY, RI 02816
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	ATC PROJ. #: 15132784_D2 CUST. ID: 4PR0700A CUST. #: 4PR0700A
	GROUNDING DETAILS
TIE CONNECTION DETAIL SCALE: N.T.S.	SHEET NUMBER: REVISION: E-501 0

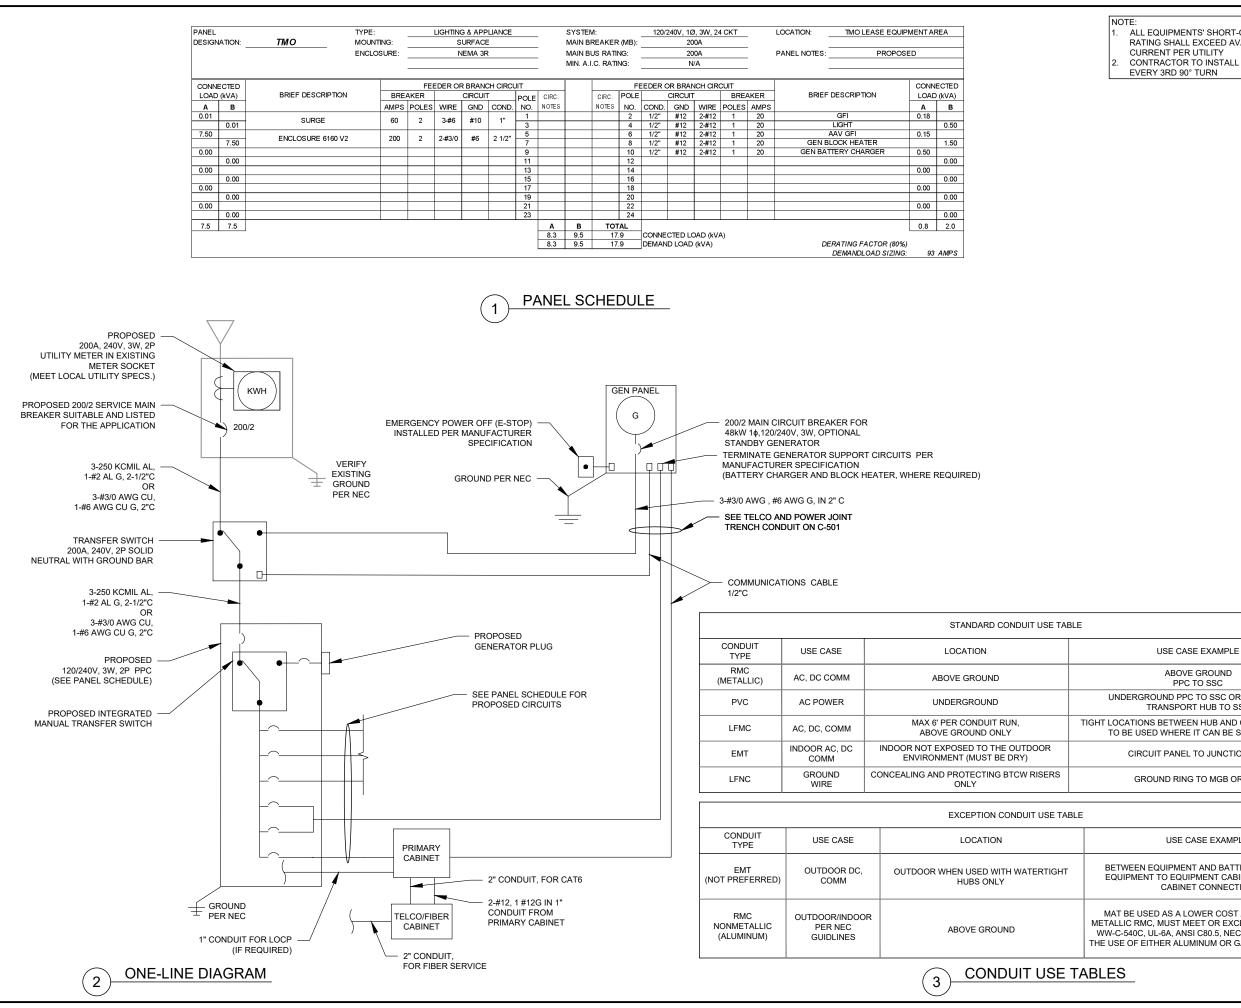



IPMENTS' SHORT-CIRCUIT CURREN
SHALL EXCEED AVAILABLE FAULT
T PER UTILITY
CTOR TO INSTALL HANDHOLES AT
RD 90° TURN

AMERICAN TOWERS L 1 FENTON MAIN SUITE 300	LC
CARY, NC 27511 PHONE: (919) 468-0112	
PE.0008090-COA	
THE USE AND PUBLICATION OF THESE SHALL BE RESTRICTED TO THE ORIGIN. WHICH THEY ARE PREPARED. ANY DISCLOSURE OTHER THAN THAT WHIC TO AMERICAN TOWER OR THE SPECIFI IS STRICTLY PROHIBITED. NEITHER THE NOR THE ENGINEER WILL BE PROVIDIN CONSTRUCTION REVIEW OF THIS PI CONTRACTOR(S) MUST VERIFY ALL DI AND ADVISE AMERICAN TOWER OR THE CARRIER OF ANY DISCREPANCIES. AI ISSUANCE OF THIS DRAWING IS SUPEF THE LATEST VERSION.	AL SITE FOR USE OR H RELATES ED CARRIER ARCHITECT IG ON-SITE ROJECT. MENSIONS E SPECIFIED NY PRIOR RSEDED BY
REV. DESCRIPTION B	Y DATE
ATC SITE NUMBER: 415799	
ATC SITE NAME:	
COVENTRY SPRING LA	KE RI
T-MOBILE SITE NAME:	
4PR0700A	
SITE ADDRESS: 60 WOOD STREET	
COVENTRY, RI 02816	
SEAL:	·····
MUSTAPHA RAHA No. REGISTERED PROFESSIONAL ENGIN ELECTRICAL	53
Ŧ··Mobile	e •'
ATC PROJ. #: 15132784_D2 CUST. ID: 4PR0700A	
CUST. #: 4PR0700A CUST. #: 4PR0700A	
PANEL SCHEDUL	E &
ONE-LINE DIAGF	RAM
SHEET NUMBER:	REVISION:
E-601	0


ABOVE GROUND PPC TO SSC
ND PPC TO SSC OR BACKHAUL NSPORT HUB TO SSC
ETWEEN HUB AND CONDUIT BUT NOT VHERE IT CAN BE STEPPED ON
PANEL TO JUNCTION BOX
D RING TO MGB OR SSC
USE CASE EXAMPLE
IPMENT AND BATTERY CABINET OR D EQUIPMENT CABINETS FOR INTER CABINET CONNECTION

MAT BE USED AS A LOWER COST ALTERNATIVE TO METALLIC RMC, MUST MEET OR EXCEED FEDERAL SPEC: WW-C-540C, UL-6A, ANSI C80.5, NEC 344.10 (A) ALLOWS THE USE OF EITHER ALUMINUM OR GALVANIZED FITTINGS

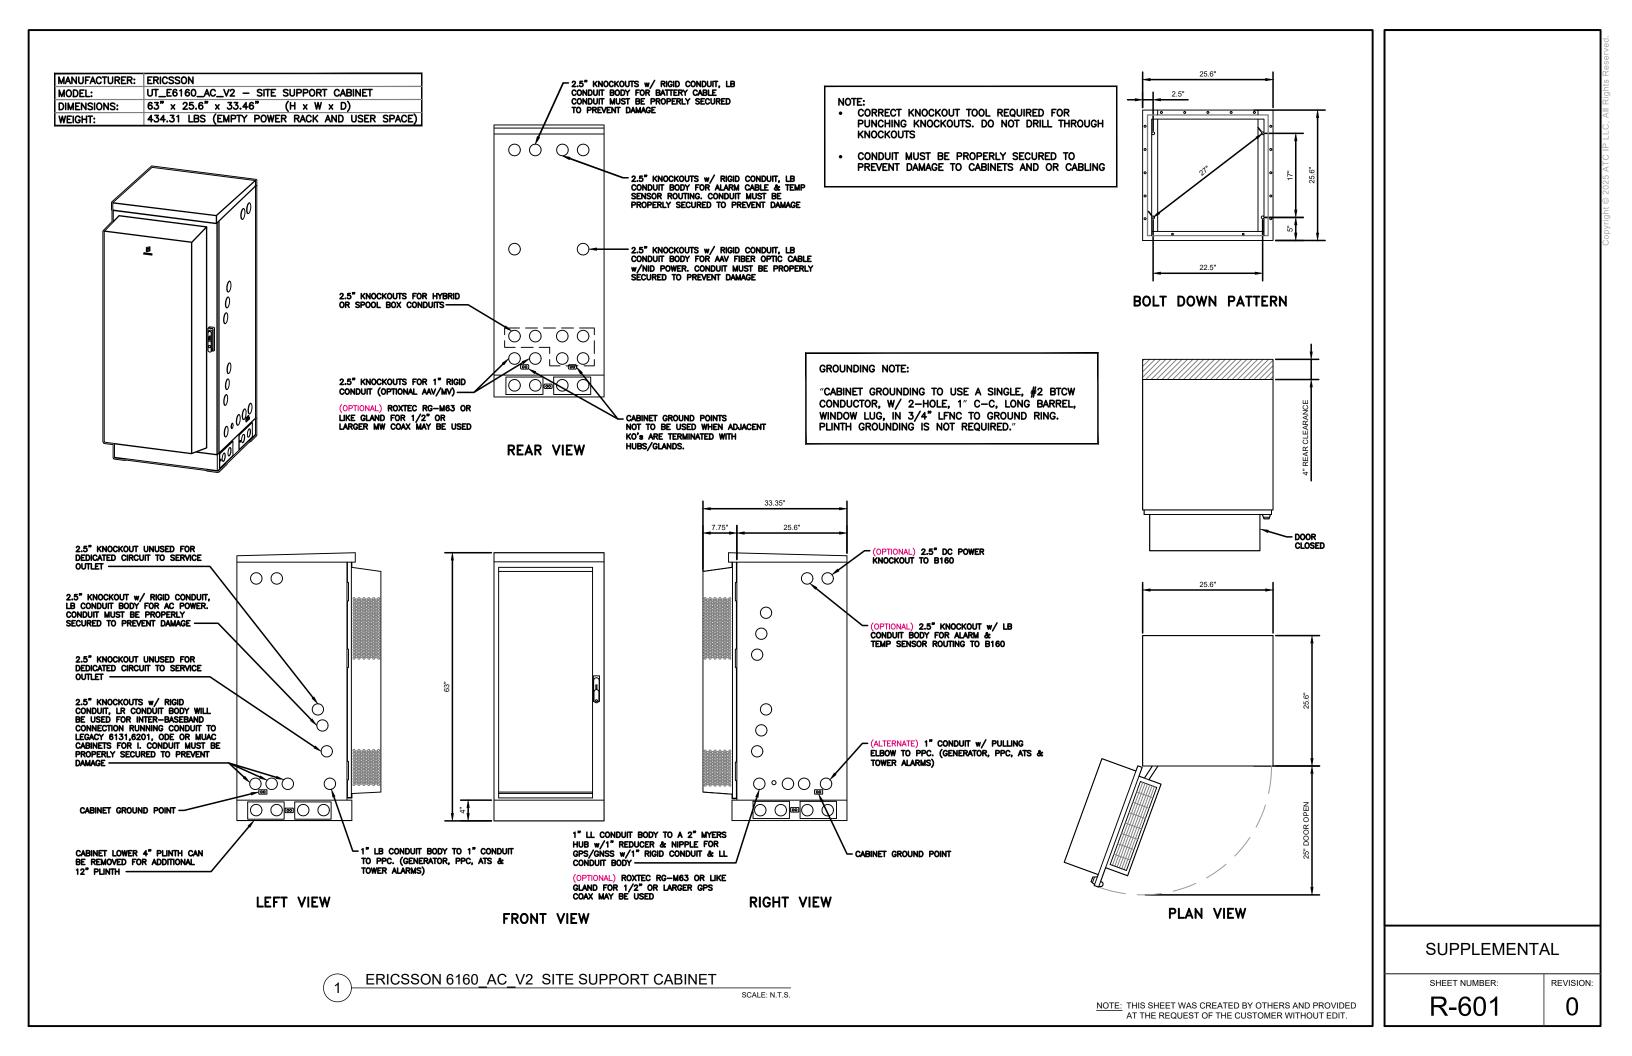

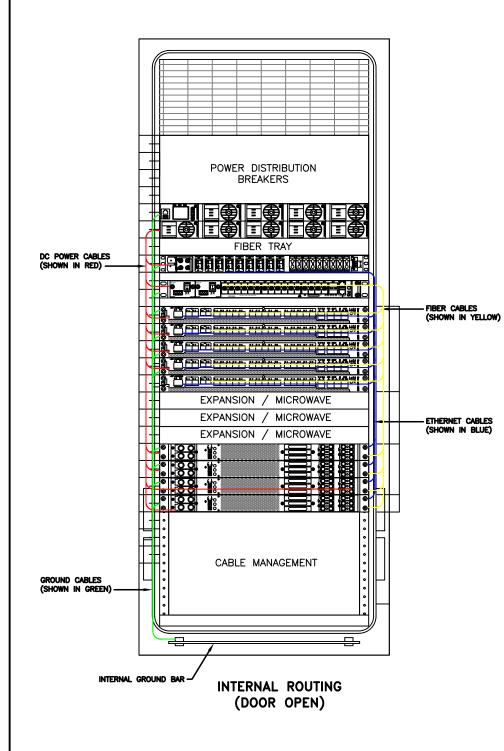

RACK ASSIGNMENTS					
RU SLOTS	DESCRIPTION				
1					
2	POWER DISTRIBUTION				
3	BREAKERS				
4					
5	RECTIFIER SHELF				
6	RECHIFIER SHELF				
7	FIBER TRAY				
8	cDCDU				
9	BACKHAUL ROUTER				
10	BACKHAOL KOOTEK				
11	1ST BASEBAND				
12	2ND BASEBAND				
13	3RD BASEBAND				
14	4TH BASEBAND				
15	5TH BASEBAND				
16	EXPANSION				
17	– MICROWAVE				
18	MICROWAVE				
19					
20	EXPANSION / PSU				
21					
22	VOLTAGE BOOSTER				
23					
24	OPEN SPACE FOR SPD ACCESS				
25					

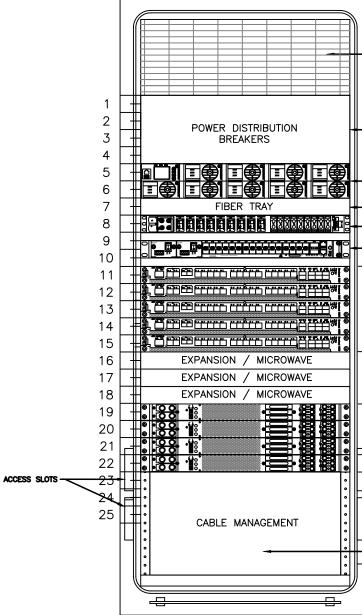


FRONT VIEW (DOOR OPEN)




SCALE: N.T.S.

)
CABLE CHASE		00
DC DISTRIBUTION		
RECTIFIERS		
FIBER TRAY		
1U cDCDU		
BASEBAND		
EXPANSION SPACE		
(BB, MW, & VB)		
EXPANSION VOLTAGE		
VOLTAGE BOOSTER		
SPACE INTENTIONALLY LEFT		
BLANK TO BE ABLE TO WORK ON INTERNAL CABLING & FOR SPD'S ON THE BOTTOM		
	SUPPLEMENTA	AL
	SHEET NUMBER:	REVISION:
CREATED BY OTHERS AND PROVIDED OF THE CUSTOMER WITHOUT EDIT.	R-602	0

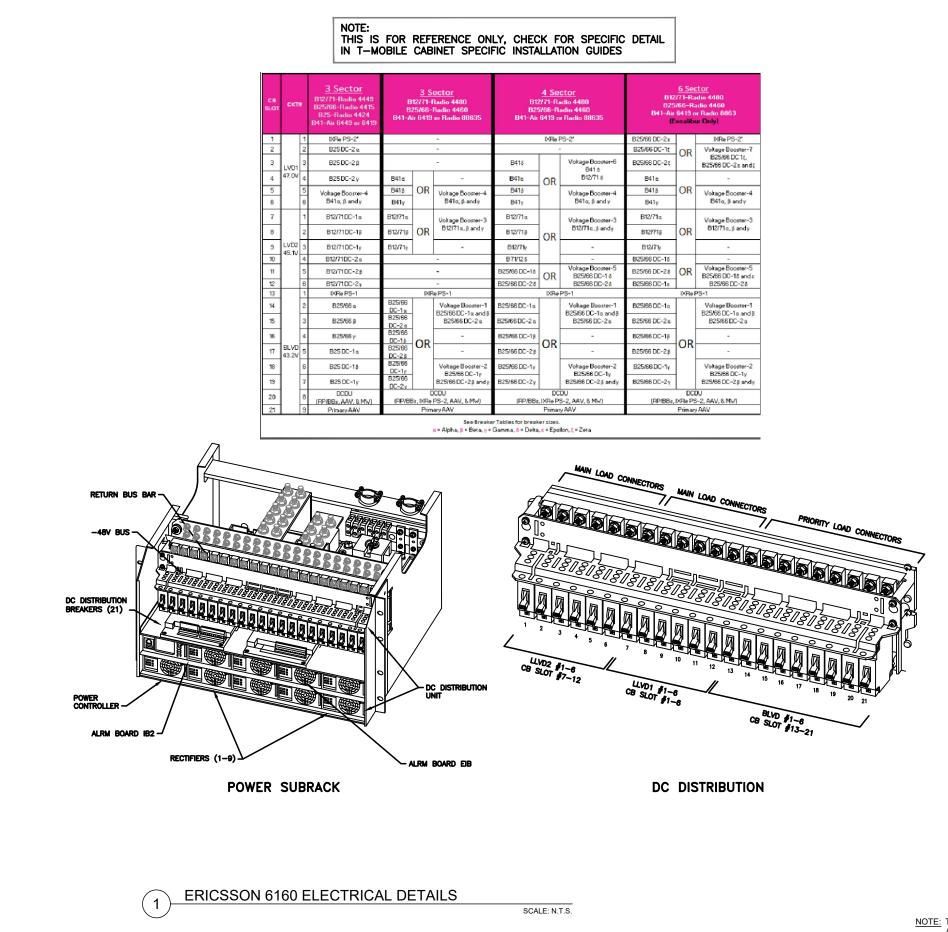





REVISION 0

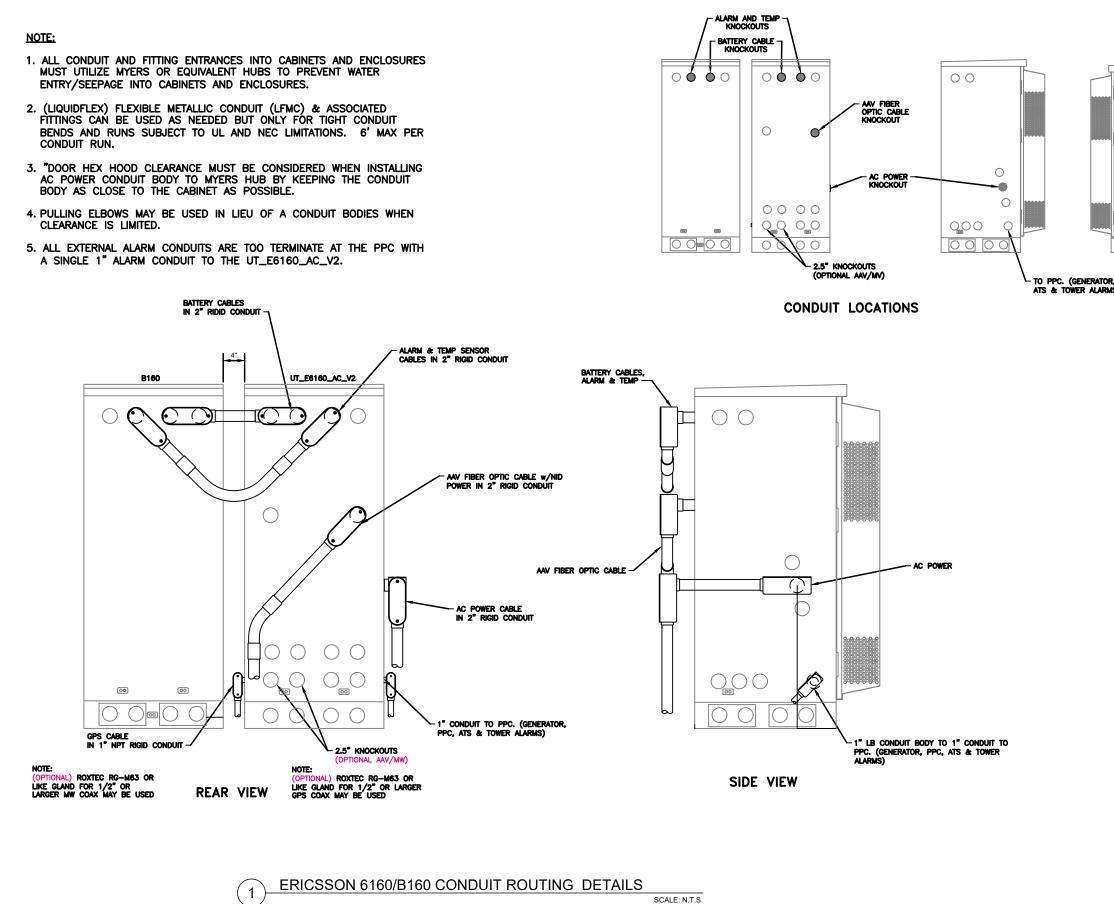


		- - - - - - - - - - - - - - - - - - -
GPS PLUG ON INSIDE R, PPC, IS)		
	SUPPLEMENTA	^L
S CREATED BY OTHERS AND PROVIDED T OF THE CUSTOMER WITHOUT EDIT.	SHEET NUMBER: R-604	REVISION:

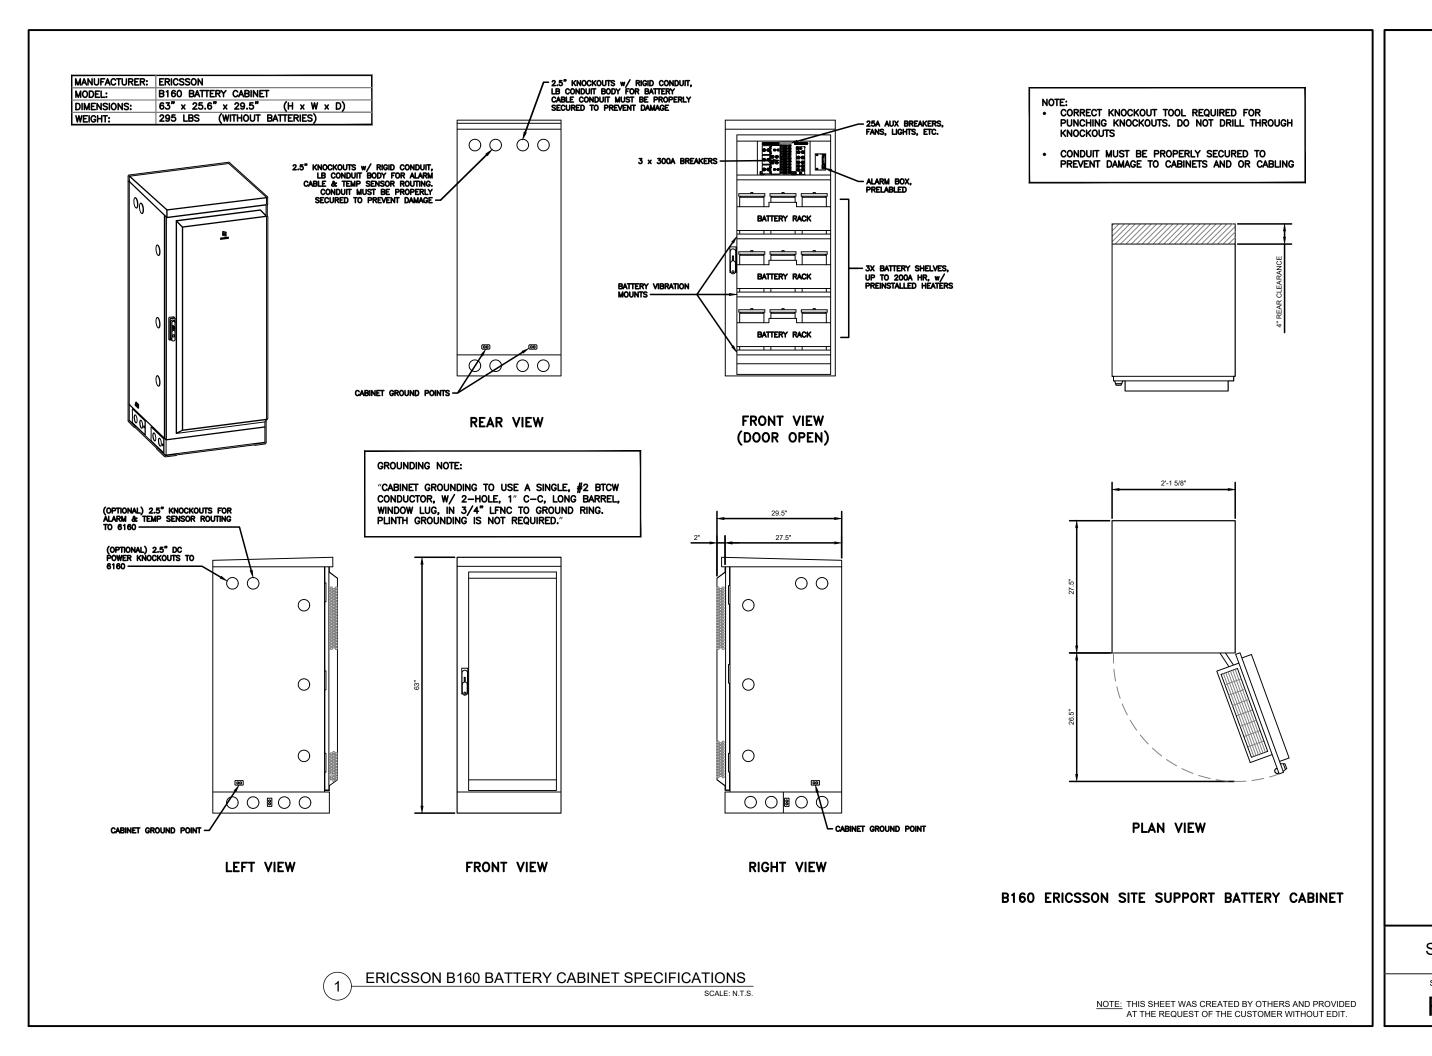




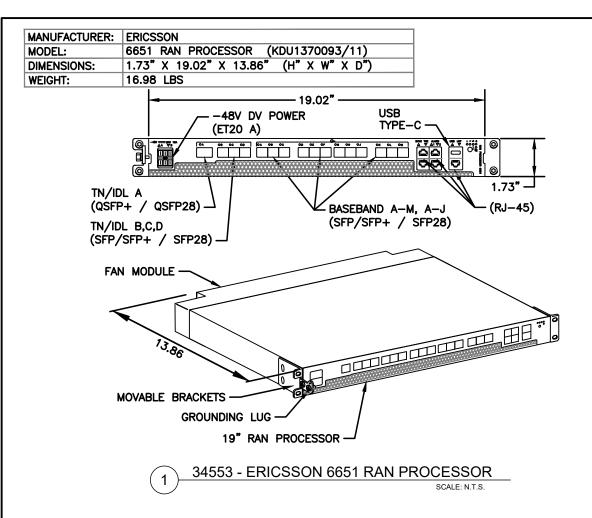


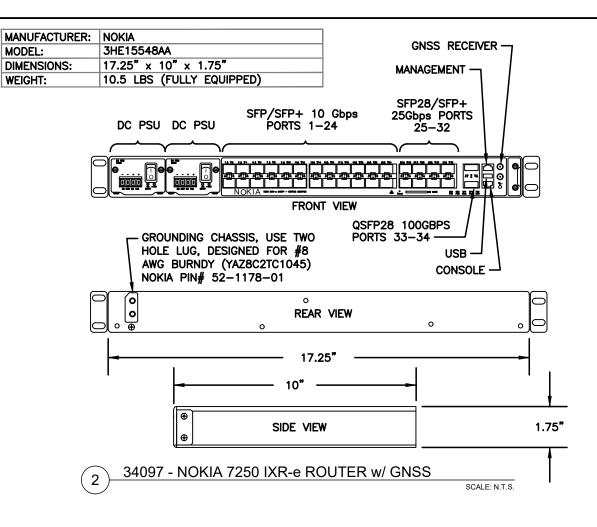

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ST OF CUSTOMER WITHOUT EDIT.	



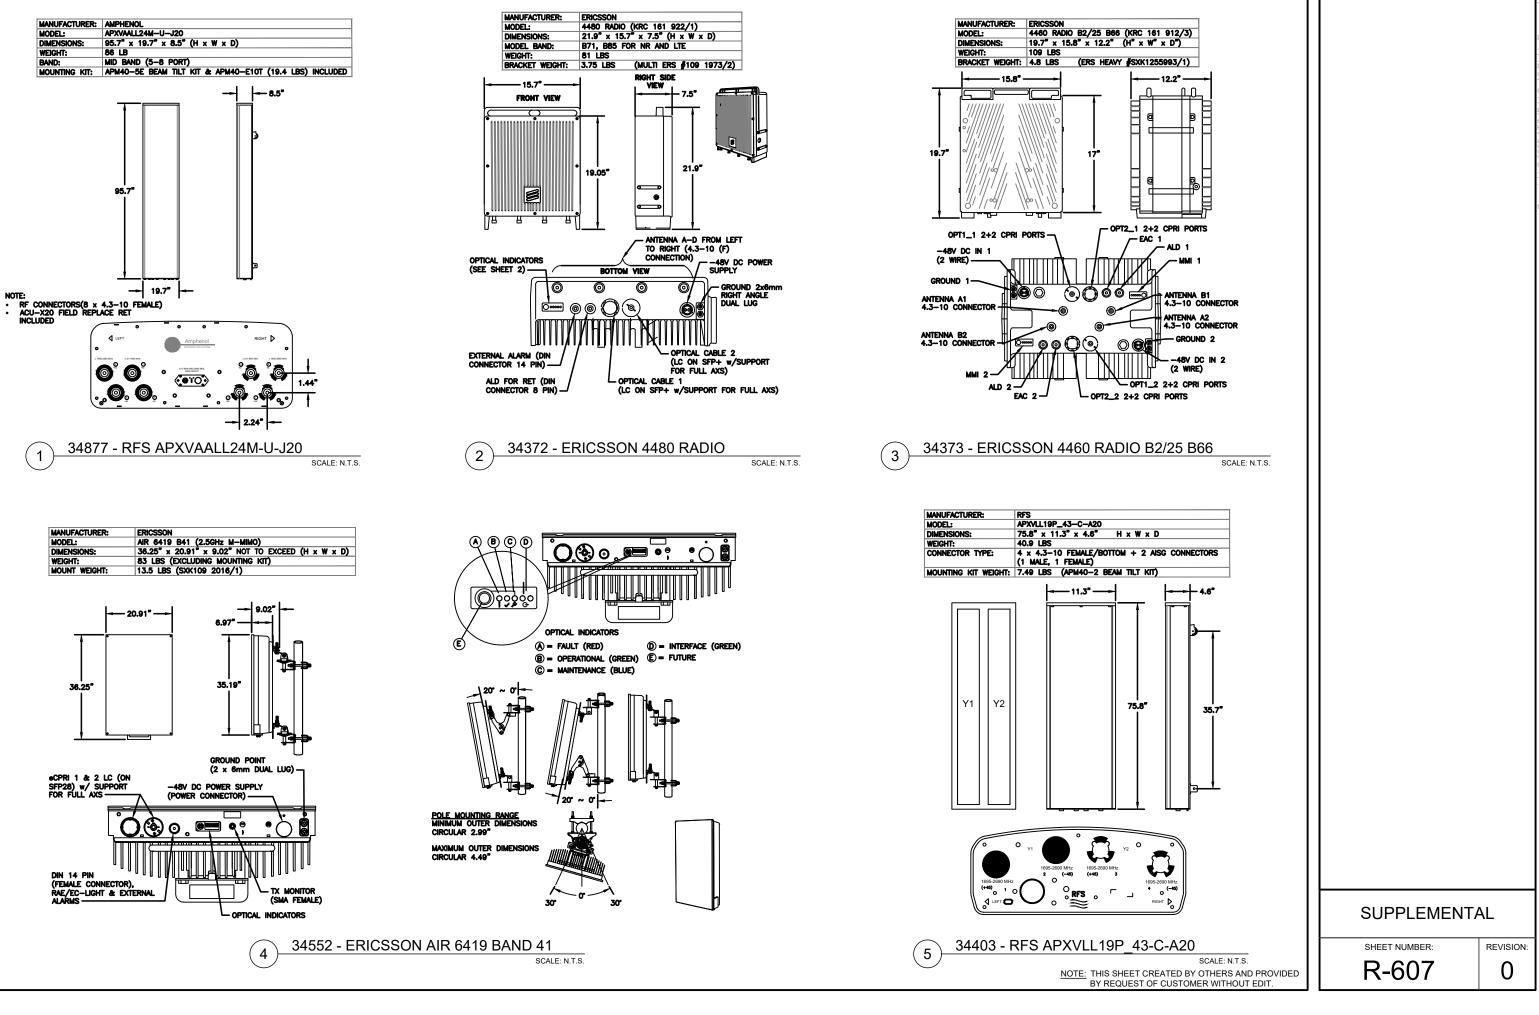

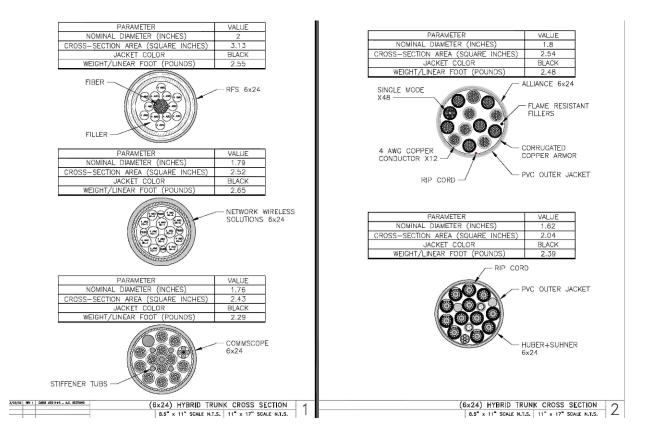

Cable Vendor	Cable Type	Nominal OD (in.)	C.S. Area (sq. in.)	Weight (lbs./ft)	enTop Breakout	MAX ENTIT	LEMENT
HC\$ 2.0	6 AWG 25' to 225'	cable lengths			HCS Pendant (Breakout) Dimension (in	.)	
Alliance	6xZ4 6AWG	1.46	1.67	1.61	16.36 x 9.30 x 5.79 (sq./in 152.15)	Nominal OD (in.)	1.55
CommScope	6x24 6AWG	1.55	1.89	1.71	19.37 x 10.83 x 5.12 (sq./in 235.07)	C.S. Area (sq./ir.)	1.89
NWS	6x24 6AWG	1.48	1.72	1.61	15.95 x 10.20 x 3.21 (sq./in 162.69)	Weight (lbs./ft)	1.71
Amphenol	6x24 6AWG	1.46	1.67	1.65	19.37 x 10.83 x 5.12 (sq./in 209.78)	Pendant (sq/in)	235.07
	4 AWG 250' to 450	' cable lengths					
Alliance	6x24 4AWG	1.8	2.54	2.48	16.36 x 9.30 x 5.79 (sq./in 152.15)	Nominal OD (in.)	1.8
CommScope	6x24 4AWG	1.76	2.43	2.4	19.37 x 10.83 x 5.12 (sq./in 235.07)	C.S. Area (sq./in.)	2.54
NWS	6x24 4AWG	1.79	2.52	2.65	15.95 x 10.20 x 3.21 (sq./in 162.69)	Weight (lbs./ft)	2.65
Amphenol	6x24 4AWG	1.71	2.3	2.55	19.37 x 10.83 x 5.12 (sq./in 209.78)	Pendant (sq/in)	235.07
6x24					óx24 Canister Breakout - OD x Length (in.)		
Alliance	6x24 4AWG	1.8	2.54	2.48	3.11 x 9.45 (c.s. Area 7.60)	Nominal OD (in.)	2
CommScope	6x24 4AWG	1.76	2.43	2.29	2.68 x 9.81 (c.s. Area 5.64)	C.S. Area (sq./in.)	3.13
H&S	6x24 4AWG	1.62	2.04	2.39	3.82 x 9.26 [c.s. Area 11.46]	Weight (lbs./ft)	2.65
NWS	6x24 4AWG	1.79	2.52	2.65	2.99 x B.82 (c.s. Area 7.02)	Canister (sq/in)	11.46
RFS	6x24 4AWG	2	3.13	2.55	2.88 x 9.72 (c.s. Area 6.51)		


(6x24) HYBRID TRUNK ENTITLEMENT INFORMATION 8.5" x 11" scale n.t.s. 11" x 17" scale n.t.s. 3

HYBRID TRUNK INFORMATION (6X24) 1

SCALE: N.T.S.



REVISION: 0

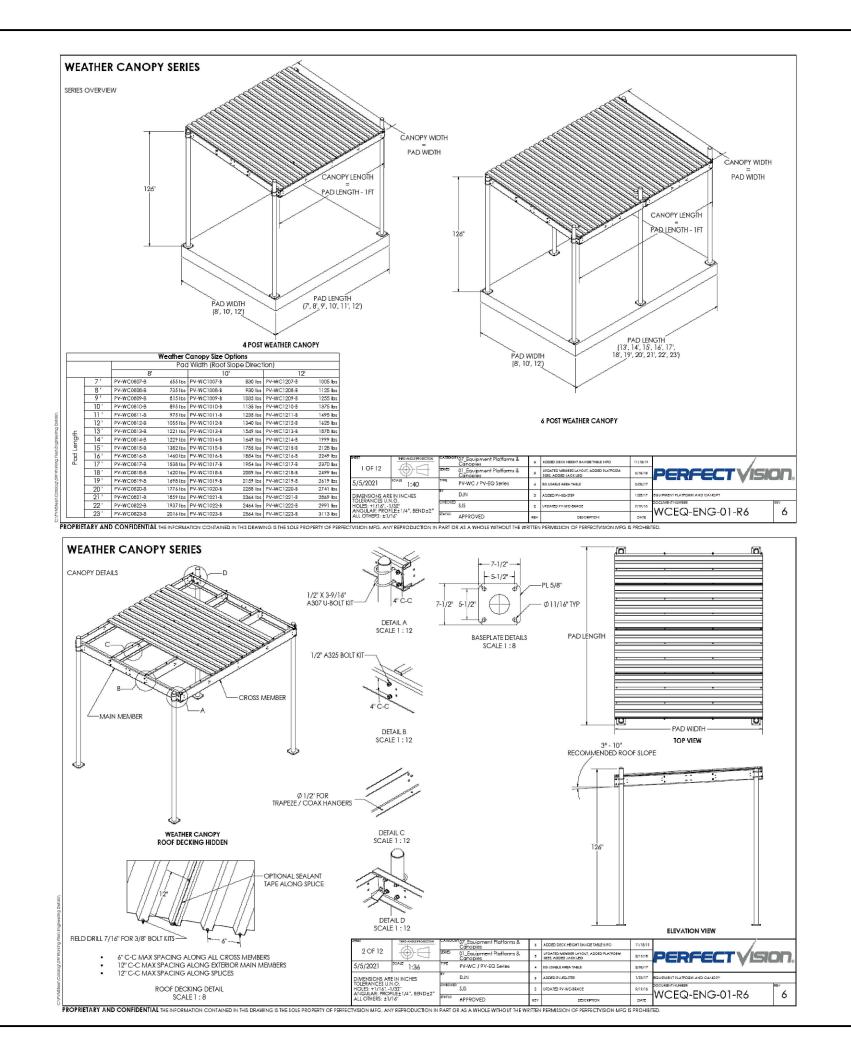



REVISION: 0



INDUSTRIAL DIESEL GENERATOR SET

EPA Certified Stationary Emergency

Standby Power Rating 48 kW, 60 Hz



Model Number 48kW: G0071940

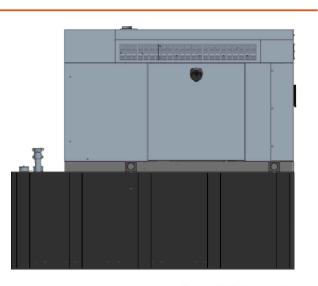




Image used for illustration purposes only

CODES AND STANDARDS Not all codes and standards apply to all configurations. Contact factory for details.



POWERING AHEAD

For over 50 years, Generac has led the industry with innovative design and superior manufacturing. Generac ensures superior quality by designing and manufacturing most of its generator components, including alternators, enclosures and base tanks, control systems and communications software.

Generac's gensets utilize a wide variety of options, configurations and arrangements, allowing us to meet the standby power needs of practically every application. Generac searched globally to ensure the most reliable engines power our generators. We choose only engines that have already been proven in heavy-duty industrial application under adverse conditions.


Generac is committed to ensuring our customers' service support continues after their generator purchase.

RD048 3.4L

INDUSTRIAL DIESEL GENERATOR SET

EPA Certified Stationary Emergency

DIMENSIONS AND WEIGHTS*

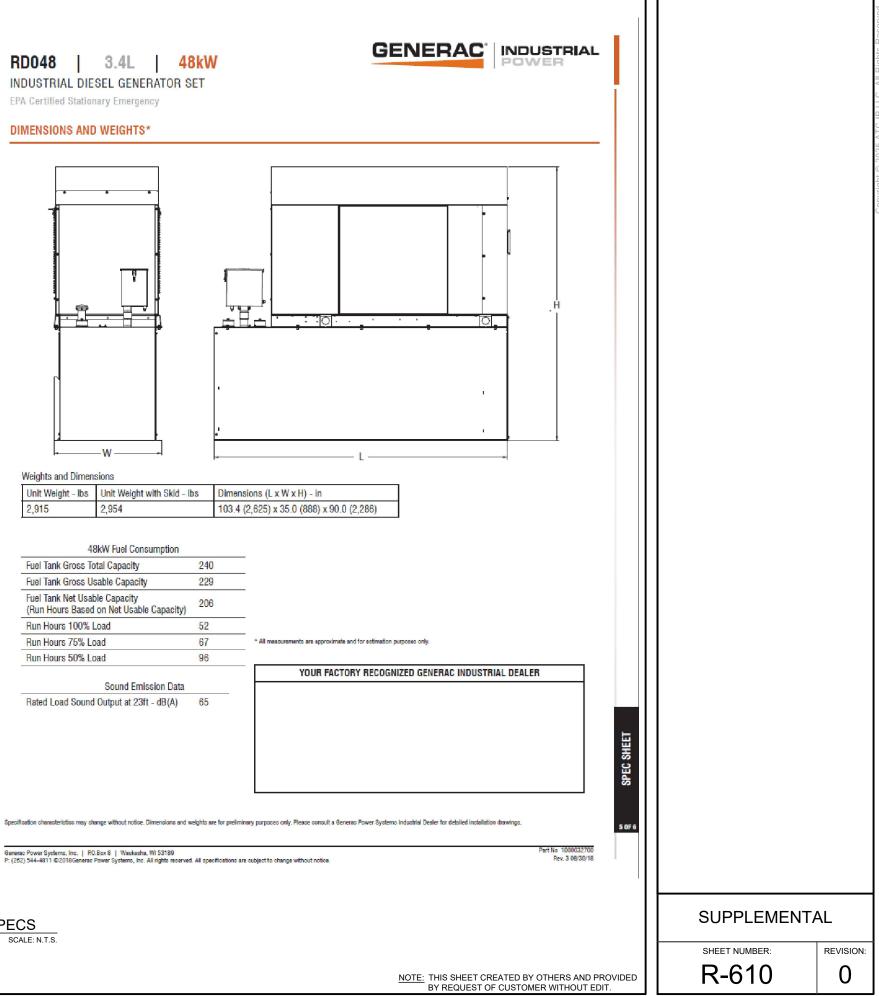

Weights and Dimensions

Unit Weight - Ibs	Unit Weight with Skid - Ibs	Dimensions (L x W x H) - in
2,915	2,954	103.4 (2,625) x 35.0 (888) x 90.0 (2,286)


48kW Fuel Consumption		
Fuel Tank Gross Total Capacity	240	
Fuel Tank Gross Usable Capacity	229	
Fuel Tank Net Usable Capacity (Run Hours Based on Net Usable Capacity)	206	
Run Hours 100% Load	52	
Run Hours 75% Load	67	* All measurements are approximate
Run Hours 50% Load	96	
		YOUR FACT

Rated Load Sound Output at 23ft - dB(A)

Specification characteristics may change without notice. Dimensions and weights are for preliminary purposes only. Please consult a Generac Power Systems Industrial Dealer for detailed installation drawings.

GENERATOR SPECS SCALE: N.T.S.

1 OF

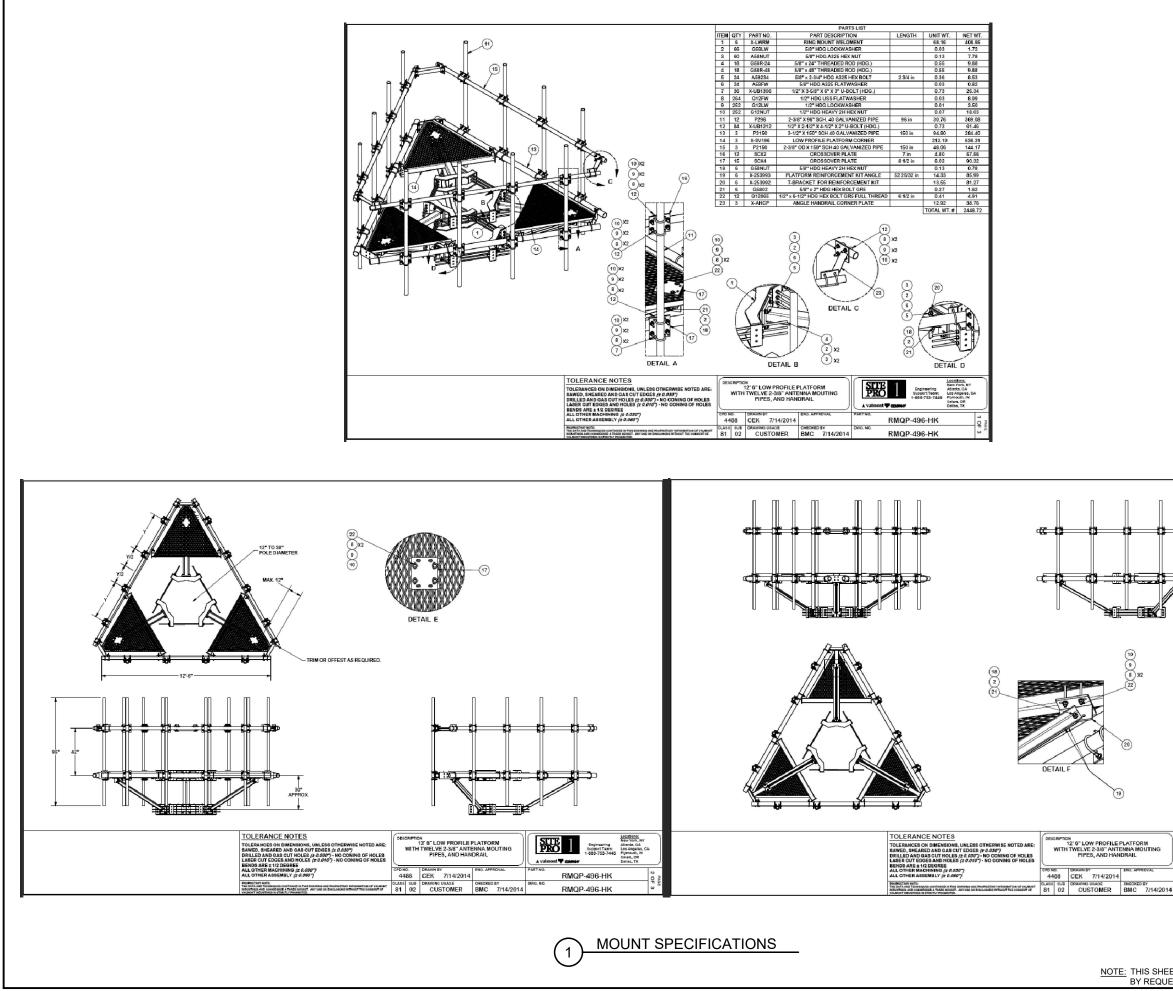

		Coovriaht © 2025 ATC IP LLC. All Rights Reserved.
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Mount Analysis Report

Mount Type	: 12.5 ft Platform w/ Handrails	
ATC Asset Name	: Coventry Spring Lake RI	
ATC Asset Number	: 415799	
Engineering Number	: 15132784_C8_01	
Mount Elevation	: 143 ft	
Proposed Carrier	: T-Mobile	
Carrier Site Name	: 4PR0700A	
Carrier Site Number	: 4PR0700A	
Site Location	: 60 Wood Street Coventry, RI 02816-5825 41.6864, -71.5633	
County	: Kent	
Date	: March 4, 2025 JOSHUA H. V	VALTON
Max Usage	: 55%	3
Analysis Result	: Pass No.	11581
Prepared By:	REGISTER	
Joseph Swier		
Structural Engineer I	Land	
Joseph Swier		iitally signed b hua Walton
		e: 2025.03.04
	Walton 22:	57:33 -05'00'

American Towers, LLC - 1 Fenton Main, Suite 300 - Cary, NC 27511 - 919.468.0112 Office - 919.466.5414 Fax - www.americanto

COA: 8090



Site Pro 1 RMQP-4096-HK, dated September 20, 2018

48 mph (3-Second Gust) w/ 1.11" radial ice concurrent ANSI/TIA-222-I

trol over Lm load cases in platform mount analyses. Therefore, these load case

RFDS ID #4PR0700A, dated February 5, 2025

The purpose of this report is to summarize results of the mount analysis performed for T-Mobile at 143 ft.

Site photos from 2022

This mount was analyzed using American Tower Corporation's Mount Analysis Program and RISA-3D

126 mph (3-Second Gust)

Sds = 0.16, Sd1 = 0.066


в Method 1 Flat

0 ft 0 ft

*Live Load(s) reduction is confirmed to either not govern or not be applicable * Based on experience, it has been determined that the Lv load cases will not o have been excluded from this analysis.

Default

Lm = 500 lbs

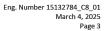



A1 A2 CA C3 RE

Conclusion

Introduction

Supporting Documents

Specifications Sheet: Radio Frequency Data Sheet:

Reference Photos:

Basic Wind Speed:

Basic Wind Speed w/ Ice:

Topographic Factor Procedure:

<u>Analysis</u>

Codes: Exposure Category: Risk Category:

Feature: Crest Height (H):

Site Class:

Live Loads:

Crest Length (L): Spectral Response

Based on the analysis results, the antenna mount meets the requirements per the applicable codes listed above. The mount can support the equipment as described in this report.

 Analysis based on new installation of Site Pro 1 RMQP-4096-HK Platform w/ Handrails(s) (M2050R(2500)-4[6]).

If you have any questions or require additional information, please reach out to your American Tower contact. If you do not have an American Tower contact and have an Engineering question, please contact MountAnalysis@americantower.com. Please include the American Tower site name, site number, and engineering number in the subject line for any questions.

American Towers, LLC - 1 Fenton Main, Suite 300 - Cary, NC 27511 - 919.468.0112 Office - 919.466.5414 Fax - www.americantower.com

Equipment Position Table

Mount Layout

	MP	RAD Center (ft)	Qty.	Antenna Model	Max Width (in)	
	A1	143.0	1	Amphenol Antel APXVAALL24M-U-J20	19.7	
		143.0	1	Ericsson Radio 4480 B71+B85	19.7	
	A2	143.0	1	Ericsson AIR 6419 B41	20	
	A3	-	-	Empty		
	A4	143.0	1	RFS APXVLL19P_43-C-A20	11.3	
		143.0	1	Ericsson Radio 4460 B25+B66	11.3	
	B1	143.0	1	Amphenol Antel APXVAALL24M-U-J20	19.7	
		143.0	1	Ericsson Radio 4480 B71+B85	19.7	
	B2	143.0	1	Ericsson AIR 6419 B41	20	
	B3	-	-	Empty	-	
	B4	143.0	1	RFS APXVLL19P_43-C-A20	11.3	
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REVISION: 0

SUPPLEMENTAL

Max Width (in)	Left (in)	Right (in)
19.7	22.55	20.65
20	20.65	69.85
-	-	-
11.3	69.85	22.55
19.7	22.55	20.65
20	20.65	69.85
-	-	-
11.3	69.85	22.55



Eng. Number 15132784_C8_01 March 4, 2025 Page 5