

GENERAL NOTES:

1. THE TEMPORARY SEDIMENT TRAP SHALL MEET ALL REQUIREMENTS FOR TEMPORARY SEDIMENT TRAPS OUTLINED IN THE RHODE ISLAND SOIL EROSION AND SEDIMENT CONTROL HANDBOOK (LATEST REVISION) SECTION SIX: SEDIMENT CONTROL MEASURES
2. THE TEMPORARY SEDIMENT TRAP MUST PROVIDE A STORAGE VOLUME FOR ONE INCH OF RUNOFF FROM THE CONTRIBUTING AREA. HALF OF THE STORAGE MUST BE PROVIDED IN THE FORM OF WET STORAGE. SEE DETAIL BELOW SECTION 6 OF THE RISESCH.
3. ALL CUT AND FILL SLOPES MUST BE 2:1 OR FLATTER EXCEPT FOR THE EXCAVATED WET STORAGE AREA WHERE SLOPES MUST NOT EXCEED 1.5:1.
4. THE OUTLET MUST BE LOCATED AT THE MOST DISTANT HYDRAULIC POINT FROM THE INLET.
5. THE OUTLET CONSISTS OF A PERVIOUS STONE DIKE WITH A CORE OF MODIFIED RIPRAP AND FACED ON THE UPSTREAM SIDE WITH STONE.
6. TEMPORARY SEDIMENT TRAPS MUST OUTLET ONTO STABILIZED GROUND.
7. MAXIMUM HEIGHT OF A TEMPORARY SEDIMENT TRAP EMBANKMENT IS LIMITED TO 5 FEET (BOTTOM OF DRY STORAGE TO TOP OF EMBANKMENT). TOTAL EMBANKMENT HEIGHT MUST NOT EXCEED 6 FEET (BOTTOM OF WET STORAGE TO TOP OF EMBANKMENT).
8. SIDE SLOPES OF THE EMBANKMENT MUST BE 2:1 OR FLATTER.
9. MODIFIED RIPRAP: SHALL MEET THE REQUIREMENTS OF RIDOT STANDARD SPECIFICATIONS FOR ROAD AND BRIDGE CONSTRUCTION SUBSECTION M.10.03.2.
10. FILTER STONE: SHALL MEET THE REQUIREMENTS OF RIDOT STANDARD SPECIFICATIONS FOR ROAD AND BRIDGE CONSTRUCTION SUBSECTION M.01.03 TABLE 1, COLUMN V FILTER STONE.

SEDIMENT TRAP DIMENSIONS*	TRAP A	B
TRIBUTARY DRAINAGE AREA	1,200 SF	200
WET STORAGE DEPTH (Dw)	1	
DRY STORAGE DEPTH (Dd)	1	
TOTAL DEPTH (D)	2	
BOTTOM OF TRAP AREA (Ab)	30 SF	
WETTED SURFACE AREA (Aw)	48 SF	
SURFACE AREA AT OUTLET (Ad)	60 SF	



*TRAP DIMENSIONS REPRESENT MINIMUM REQUIRED SIZING TO MEET THE RISESCH. CONTRACTOR MAY SHAPE TRAP DIFFERENTLY THAN SHOWN ON PLANS AS LONG AS THE MINIMUM SIZING HAS BEEN PROVIDED.

INSPECTION, MAINTENANCE, AND REMOVAL REQUIREMENTS:

1. INSTALL "SEDIMENT STORAGE" STAKE WITH A MARKER AT ONE HALF OF THE WET STORAGE VOLUME.
2. INSPECT THE TEMPORARY SEDIMENT TRAP AT LEAST ONCE A WEEK AND WITHIN 24 HOURS OF THE END OF A STORM WITH A RAINFALL AMOUNT OF 0.25 INCH OR GREATER.
3. CHECK THE OUTLET TO ENSURE THAT IT IS STRUCTURALLY SOUND AND HAS NOT BEEN DAMAGED BY EROSION OR CONSTRUCTION EQUIPMENT.
4. CHECK FOR SEDIMENT ACCUMULATION AND FILTRATION PERFORMANCE.
5. WHEN SEDIMENTS HAVE ACCUMULATED TO ONE HALF THE MINIMUM REQUIRED VOLUME OF THE WET STORAGE, DEWATER THE TRAP AS NEEDED, REMOVE SEDIMENTS AND RESTORE THE TRAP TO ITS ORIGINAL DIMENSIONS.
6. DISPOSE OF THE SEDIMENT REMOVED FROM THE BASIN IN A SUITABLE AREA AS DESIGNATED BY THE GEOTECHNICAL ENGINEER.
7. THE TEMPORARY SEDIMENT TRAP MAY BE REMOVED AFTER THE CONTRIBUTING DRAINAGE AREA IS STABILIZED.

INSTALLATION NOTES:

1. CLEAR, GRUB AND STRIP ANY VEGETATION AND ROOT MAT FROM ANY PROPOSED EMBANKMENT AND OUTLET AREA.
2. REMOVE STONES AND ROCKS WHOSE DIAMETER IS GREATER THAN THREE (3) INCHES AND OTHER DEBRIS.
3. EXCAVATE WET STORAGE AND CONSTRUCT THE EMBANKMENT AND/OR OUTLET AS NEEDED TO ATTAIN THE NECESSARY STORAGE REQUIREMENTS.
4. USE ONLY FILL MATERIAL FOR THE EMBANKMENT THAT IS FREE FROM EXCESSIVE ORGANICS, DEBRIS, LARGE ROCKS (OVER SIX (6) INCHES) OR OTHER UNSUITABLE MATERIALS. COMPACT THE EMBANKMENT IN 9-INCH LAYERS BY TRAVERSING WITH EQUIPMENT WHILE IT IS BEING CONSTRUCTED.
5. STABILIZE THE EARTHEN EMBANKMENT USING ANY OF THE FOLLOWING MEASURES: SEEDING FOR TEMPORARY VEGETATION COVER; SEEDING FOR PERMANENT VEGETATIVE COVER; OR SLOPE PROTECTION, IMMEDIATELY AFTER INSTALLATION.

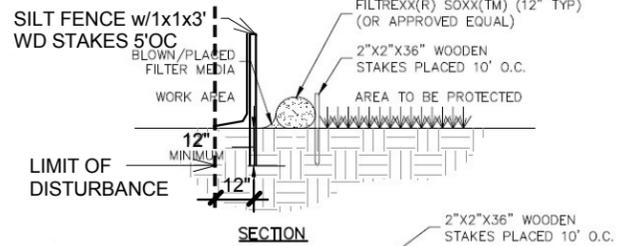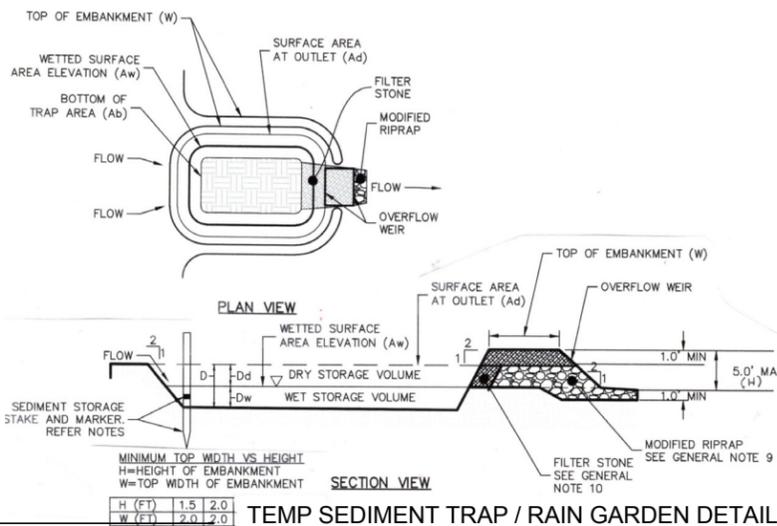

TES:

ALL MATERIAL TO MEET FILTREXX(R) SPECIFICATIONS. FILTER MEDIA(TM) FILL TO MEET APPLICATION REQUIREMENTS. COMPOST MATERIAL TO BE DISPERSED ON SITE, AS DETERMINED BY ENGINEER. STAKES ARE NOT TO BE USED IN PAVEMENT AREAS. SELF WEIGHT OF FILTREXX SYSTEM IS ADEQUATE TO PREVENT SYSTEM MOVEMENT ONCE POSITIONED ALONG AREA SHOWN ON THE PLANS. CONTRACTOR TO PLACE FILTREXX SEDIMENT CONTROL OR APPROVED EQUAL AROUND ALL CURB INLET LOCATIONS AS SPECIFIED ON PLANS.

Filtrexx Sediment Control (or Approved Equal)

Soil Erosion Control

DIVERSION RUNOFF CONVEYANCE MEASURE (SWALE AND/OR BERM)

TEMPORARY SEDIMENT TRAP

EROSION CONTROL (COMPOST SOCK, SILT FENCE (R1 STD 9.2.0) OR APPROVED EQUAL) LIMIT OF DISTURBANCE (NO SEDIMENT CONTROL)

TRIBUTARY AREA TO SESC BMP



CONSTRUCTION ENTRANCE (RIDOT STD 9.9.0)

INFILTRATING AREA (TO BE PROTECTED BY COMPOST SOCK OR SILT FENCE)

FINAL CONTOUR GRADE

INLET SEDIMENT CONTROL

DRYWELL/ YARD DRAIN

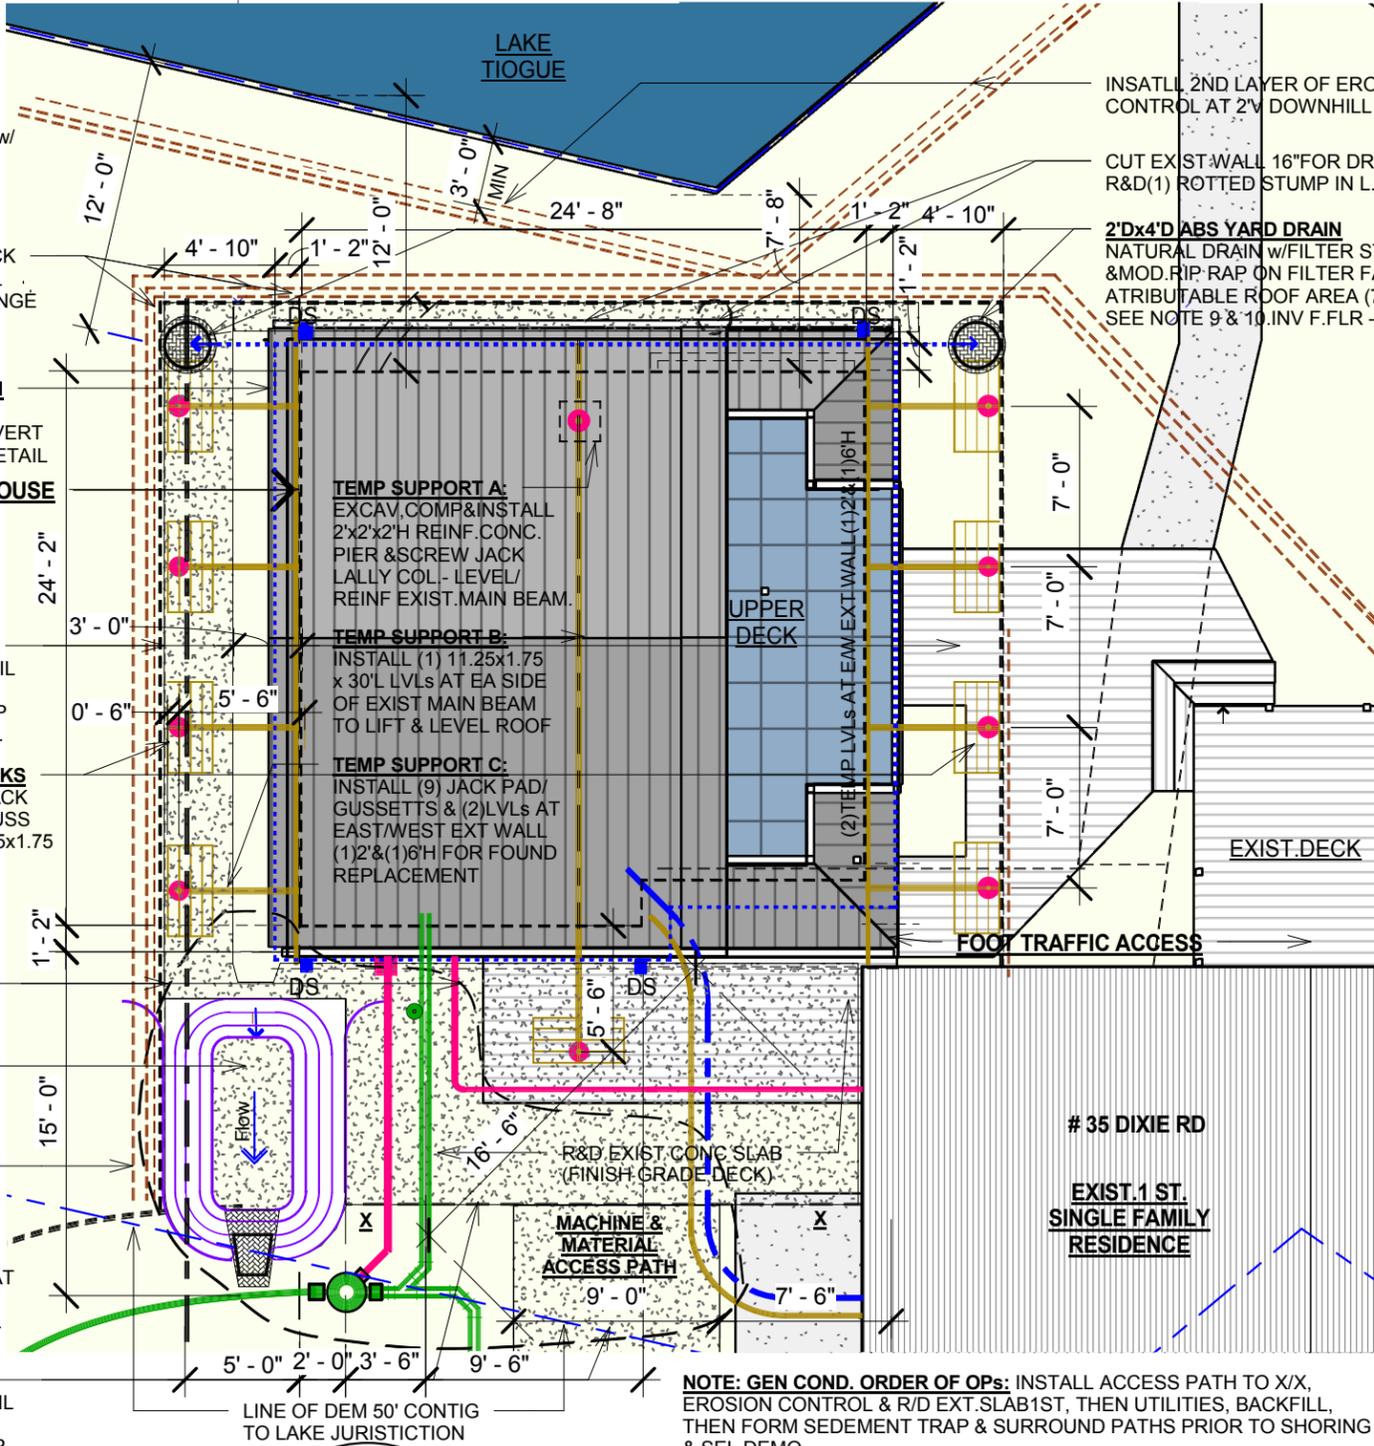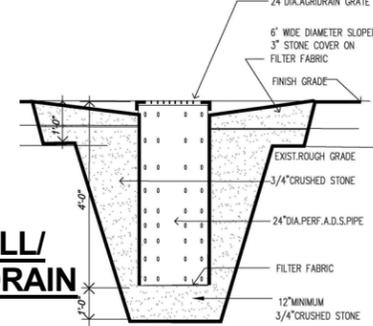

Soil Erosion Control Implementation Phasing

- Phase IA - INSTALL EROSION CONTROL SILT FENCE & STONE CONSTRUCTION ENTRANCE R&D EXTERIOR SLAB, INSTALL UTILITIES, BACKFILL
- Phase IB - INSTALL TEMPORARY SEDIMENT TRAP CONSTRUCT C/FAN WATER DIVERSION/INSTALL E/W TEMP GUTTER & TEMP SHORING
- Phase III SELECTIVE DEMO, EXCAVATE, 3/4" STONE & PERIM DRAIN
- Phase II INSTALL V.B., INSUL SKIRT, ICF FORMS & MONOLITHIC SLAB. BACKFILL, STONE 1" PERIM, RAKE BACK WD CHIPS TO STONE, INSTALL **SEDIMENT TRAP B** FILTER STONE/RIP RAP UNCAP DRAIN.

LIMIT OF DISTURBANCE LINE (BLACK DASHED LINE) INSTALL/ MAINT DBL DEVICE EROSION CONTROL: (ORANGE DASHED LINE) w/ HAYFILLED SOCK & SILT FENCE SEE DETAIL.

PERFERATED PERIMETER DRAIN 4" PVC WRAP w/ FILTER FAB UNDER RIGID INSUL 14" OFF FND NAT TO VERT ABS w/ GRATE YARD DRAIN, SEE DETAIL

EXIST. 1 ST. ACCESSORY POOLHOUSE PROPOSED ADU w/ 2ND FLR ADDITION & ALTS TO ADU

3'w TEMP SITE ACCESS PATHWAY COMPACT EXIST. ORGANIC TOPSOIL INSTALL 8'w GEOGRID FABRIC INSTALL MIN 6" WD CHIPS & RETOP AS REQ'D TO SUBST COMPLETION.

TEMP SHORING PAD/GUSSETT/JACKS (4) 2'x4'x6'x6" LIFT PADS w/ BOTTLE JACK & 6'Lx4'H PLY 2x10/3/4 OSB WD TRUSS GUSSETTS & HANGERS TO (2) 11.25x1.75 LVLs AT 1' & 5' A.F.F.L. AT 7'-0" OC

EXIST. 5'D OPEN EXCAVATION TO REMAIN UNTIL AFTER UTILITY INSTALLATION IS COMPLETE

TEMP SEDIMENT TRAP A RESHAPE EXIST. EXCAV. FOR TEMP SEDIMENT TRAP 30SF SEE DETAIL C-2.3

RESTORATION: AT SUBSTANTIAL COMPLETION: INSTALL 1'wx4'd PEA STONE AT FOUND ON WEED BARRIER. RAKE BACK WD CHIPS TO PEA STONE & 4'H GALV. FARM FENCE w/ GATE. AT PROP LINE. (LEAVE SILT FENCE IN PLACE FOR (1) SEASON & INSTALL 6'L&WILD FLOWER SEED)

TEMP SITE ACCESS PATHWAY COMPACT EXIST. ORGANIC TOPSOIL INSTALL 8'w GEOGRID FABRIC INSTALL MIN 6" WD CHIPS & RETOP AS REQ'D TO SUBST COMPLETION.

TREE PROTECTION PROTECT TRUNKS OF (2) 24" C EXIST OAK TREES TO REMAIN w/ 4'H SNOW FENCE

NOTE: GEN COND. ORDER OF OPS: INSTALL ACCESS PATH TO X/X, EROSION CONTROL & R/D EXT. SLAB 1ST, THEN UTILITIES, BACKFILL, THEN FORM SEDIMENT TRAP & SURROUND PATHS PRIOR TO SHORING & SEL DEMO.

SITE TEMP COND PLAN
SCALE: 1/8" = 1'-0"



REL. 4
FOR ZBR
VARIANCE REQUEST
C-2.0

03/12/2026



© 2026 Joseph N McPhee, II - Arch

Joseph N. McPhee, II - Architect

Planning - Architecture - Design / Build

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LAKESIDE ACCESSORY DWELLING UNIT

ALTERATIONS & 2ND FLR ADDITION

35 DIXIE ROAD
COVENTRY, RHODE ISLAND

TEMP COND SITE PLAN

02/25/25

Rel/ Issue Date:

Drawn by: JNM, II Checked by: JNM, II

Scale: 1/8" = 1'-0"