COMPREHENSIVE PERMIT MASTER PLAN

OF

COVENTRY CROSSINGS

A.P.10, LOT 29 & A.P. 18, LOT 86
HARKNEY HILL ROAD
COVENTRY,
RHODE ISLAND

OWNERS:
A.P. 10, LOT 29
KOSZELA JOHN & ECCLESTON
WILLIAM REV TRUST ET AL
1315 VICTORY HIGHWAY
GREENE RI 02827

A.P. 18, LOT 86
ECCLESTON ELAINE M. REVOCABLE TRUST
AGREEMENT C/O
ECCLESTON ELAINE TTE
8 CEDAR RIDGE LN UNIT 67
WEST GREENWICH, RI 02817

APPLICANT:
KREG NEW HOMES LLC
39 NOOSENECK HILL ROAD
WEST GREENWICH, RI 02817

LEGAL COUNSEL:
WILLIAM LANDRY
BLISH & CAVANAGH, LLP
30 EXCHANGE TERRACE
PROVIDENCE, RI 02903-1765



LOCUS MAP

NOT TO SCALE

PREPARED BY:







JOB NO. 7398-00

DATE: AUGUST, 2023

(REVISED: OCTOBER 10, 2023)

SHEET INDEX PLAN TITLE LATEST REVISION COVER SHEET VICINITY MAP G-2 **AERIAL PLAN ECS EXISTING CONDITIONS SURVEY** GENERAL NOTES & LEGEND OVERALL SITE LAYOUT PLAN SITE LAYOUT PLAN - 1 SITE LAYOUT PLAN - 2 OVERALL DRAINAGE & UTILITY PLAN DRAINAGE & UTILITY PLAN - 1 DRAINAGE & UTILITY PLAN - 2 OFFSITE UTILITIES PLAN SOIL EROSION & SEDIMENT CONTROL PLAN OVERALL CONCEPTUAL LANDSCAPE PLAN CONCEPTUAL LANDSCAPE PLAN - 1 CONCEPTUAL LANDSCAPE PLAN - 2

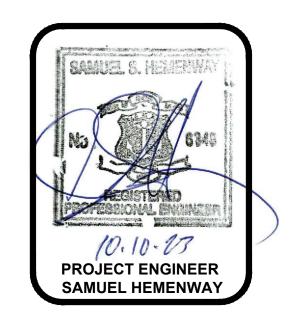

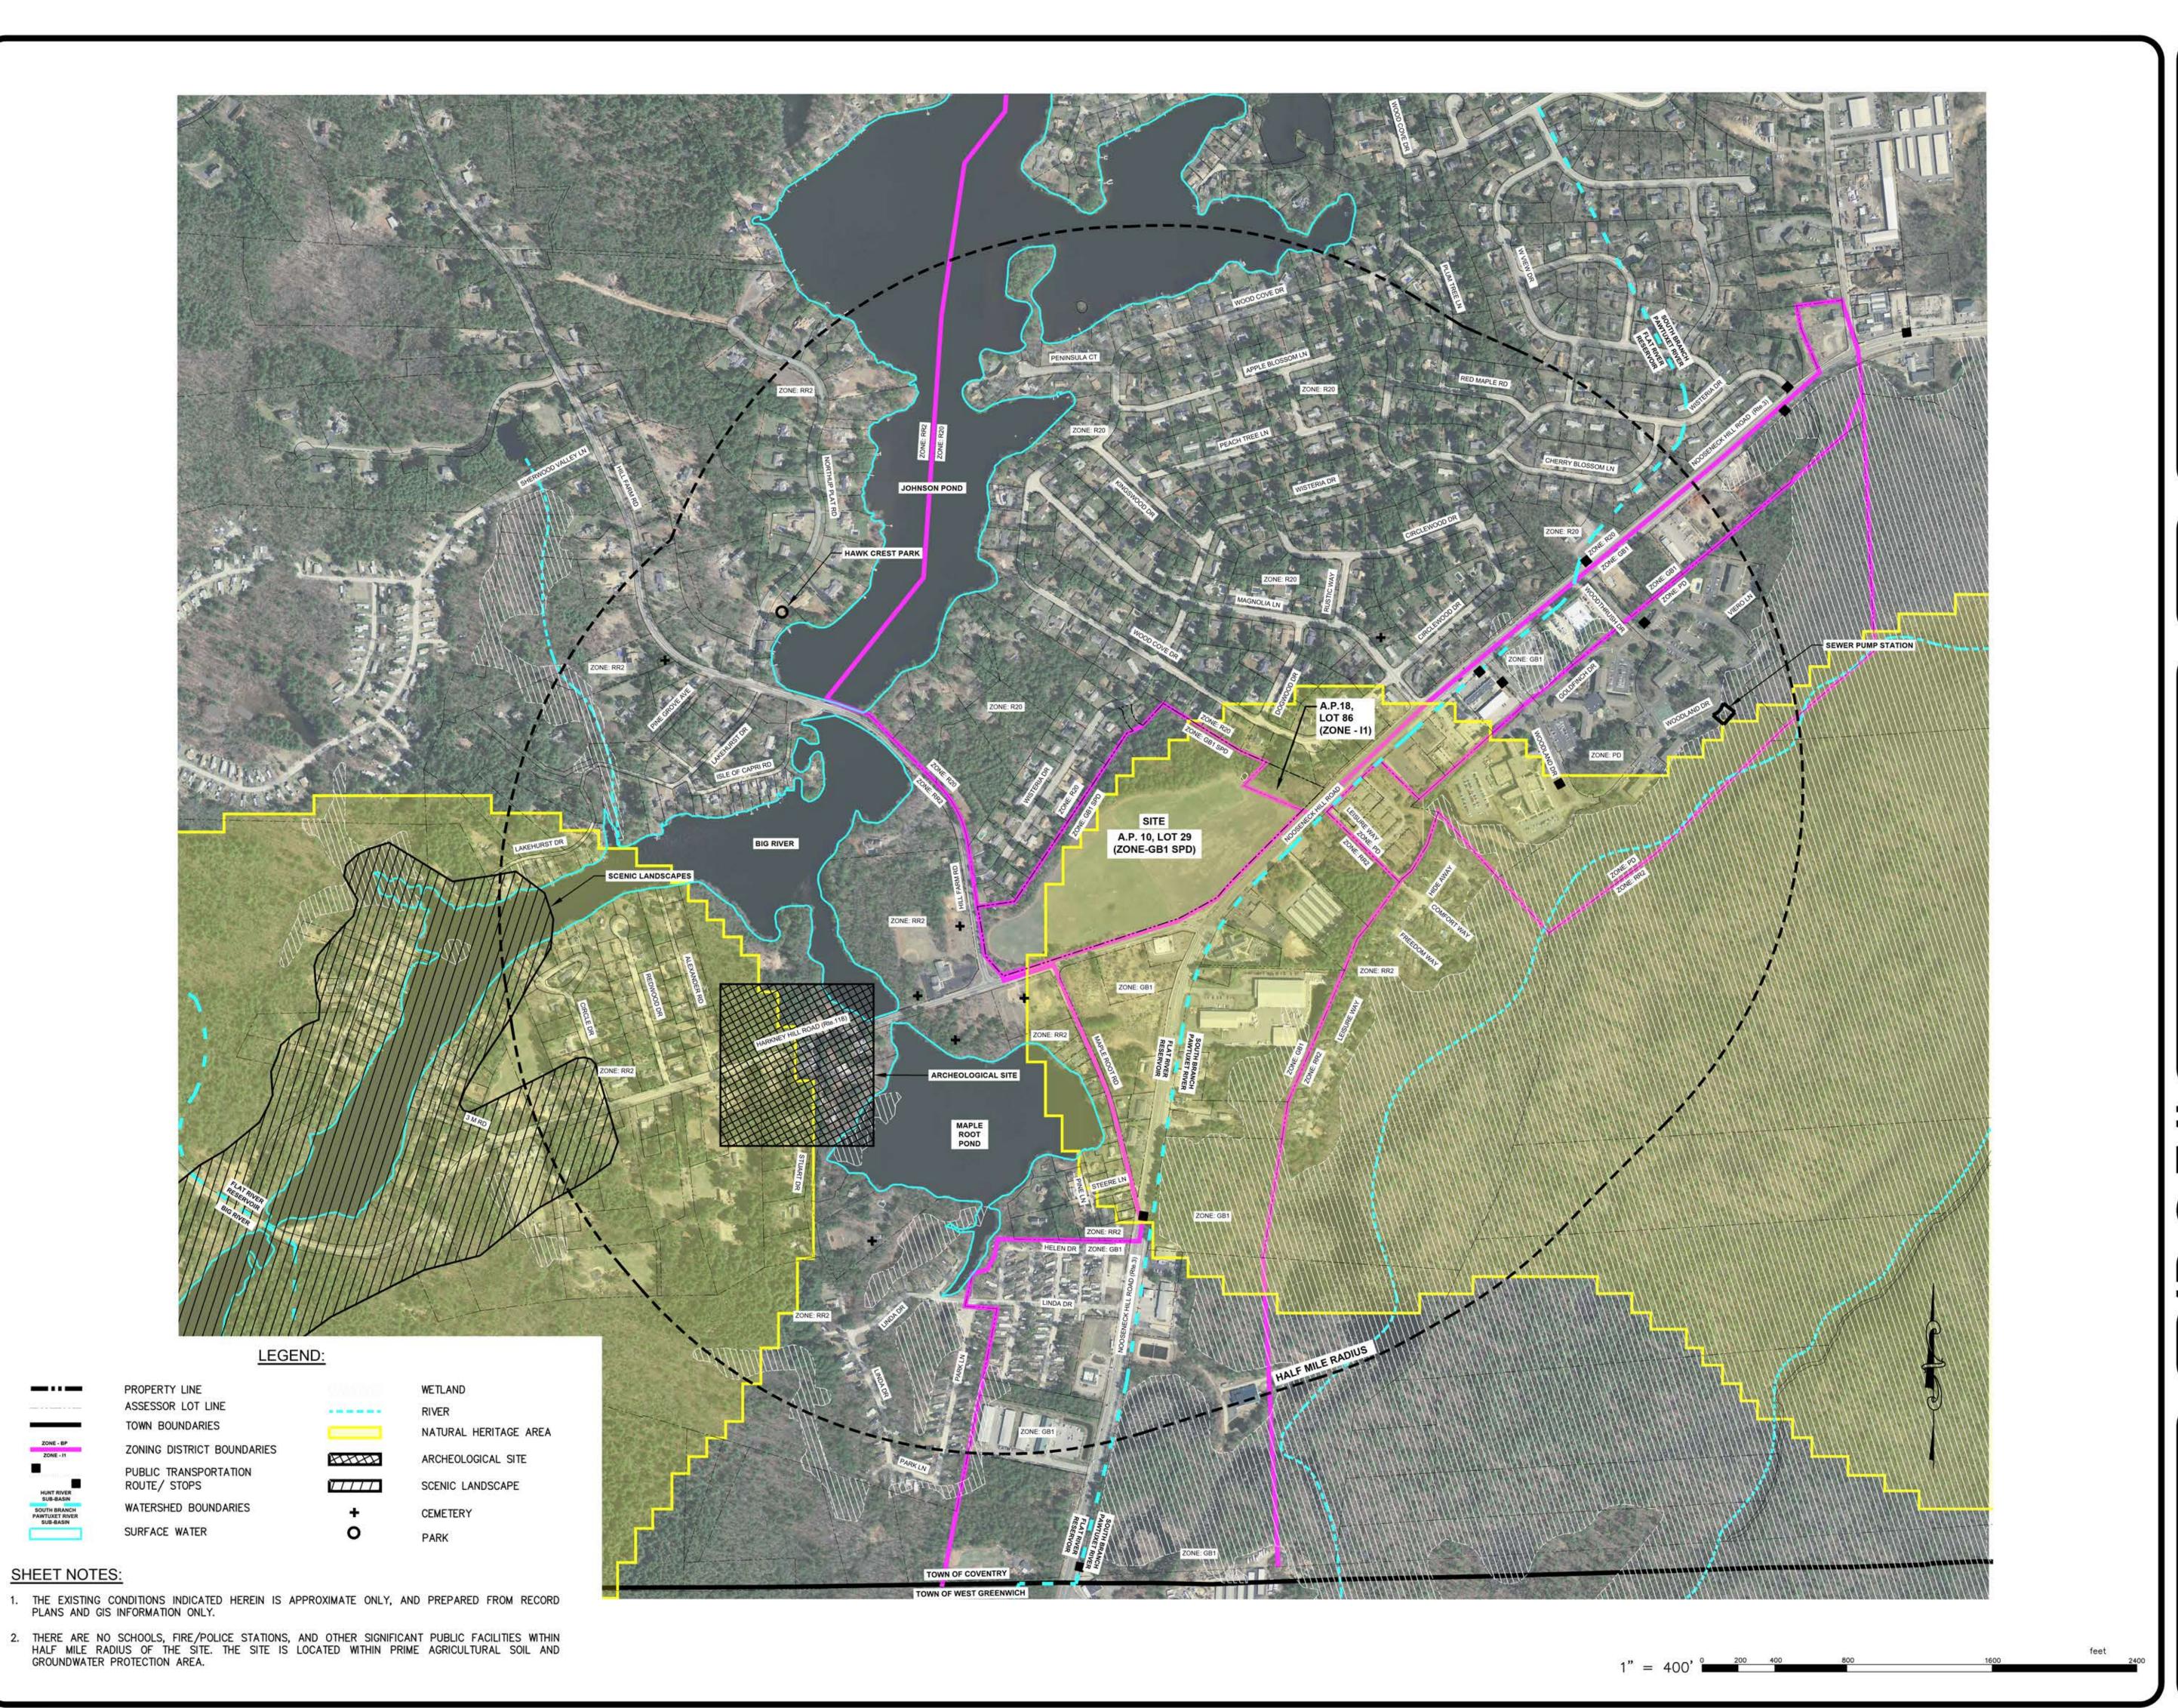

BY DATE REVISION

PROJECT ENGINEER SAMUEL HEMENWAY

JOB NO. DRAWN BY K.Y.Y. 7398-00 **DWG. NO**. CHECK BY S.S.H. 7398-00_MP-Vicinity&Aerial Map APPROVED S.B.G. SCALE: AS SHOWN

DATE:

AUGUST, 2023

SHEET



REVISION

BY DATE

PROJECT ENGINEER SAMUEL HEMENWAY

DATE:

DRAWN BY K.Y.Y.


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APPROVED S.B.G.

AUGUST, 2023

3 OF 16 SHEETS

AS SHOWN

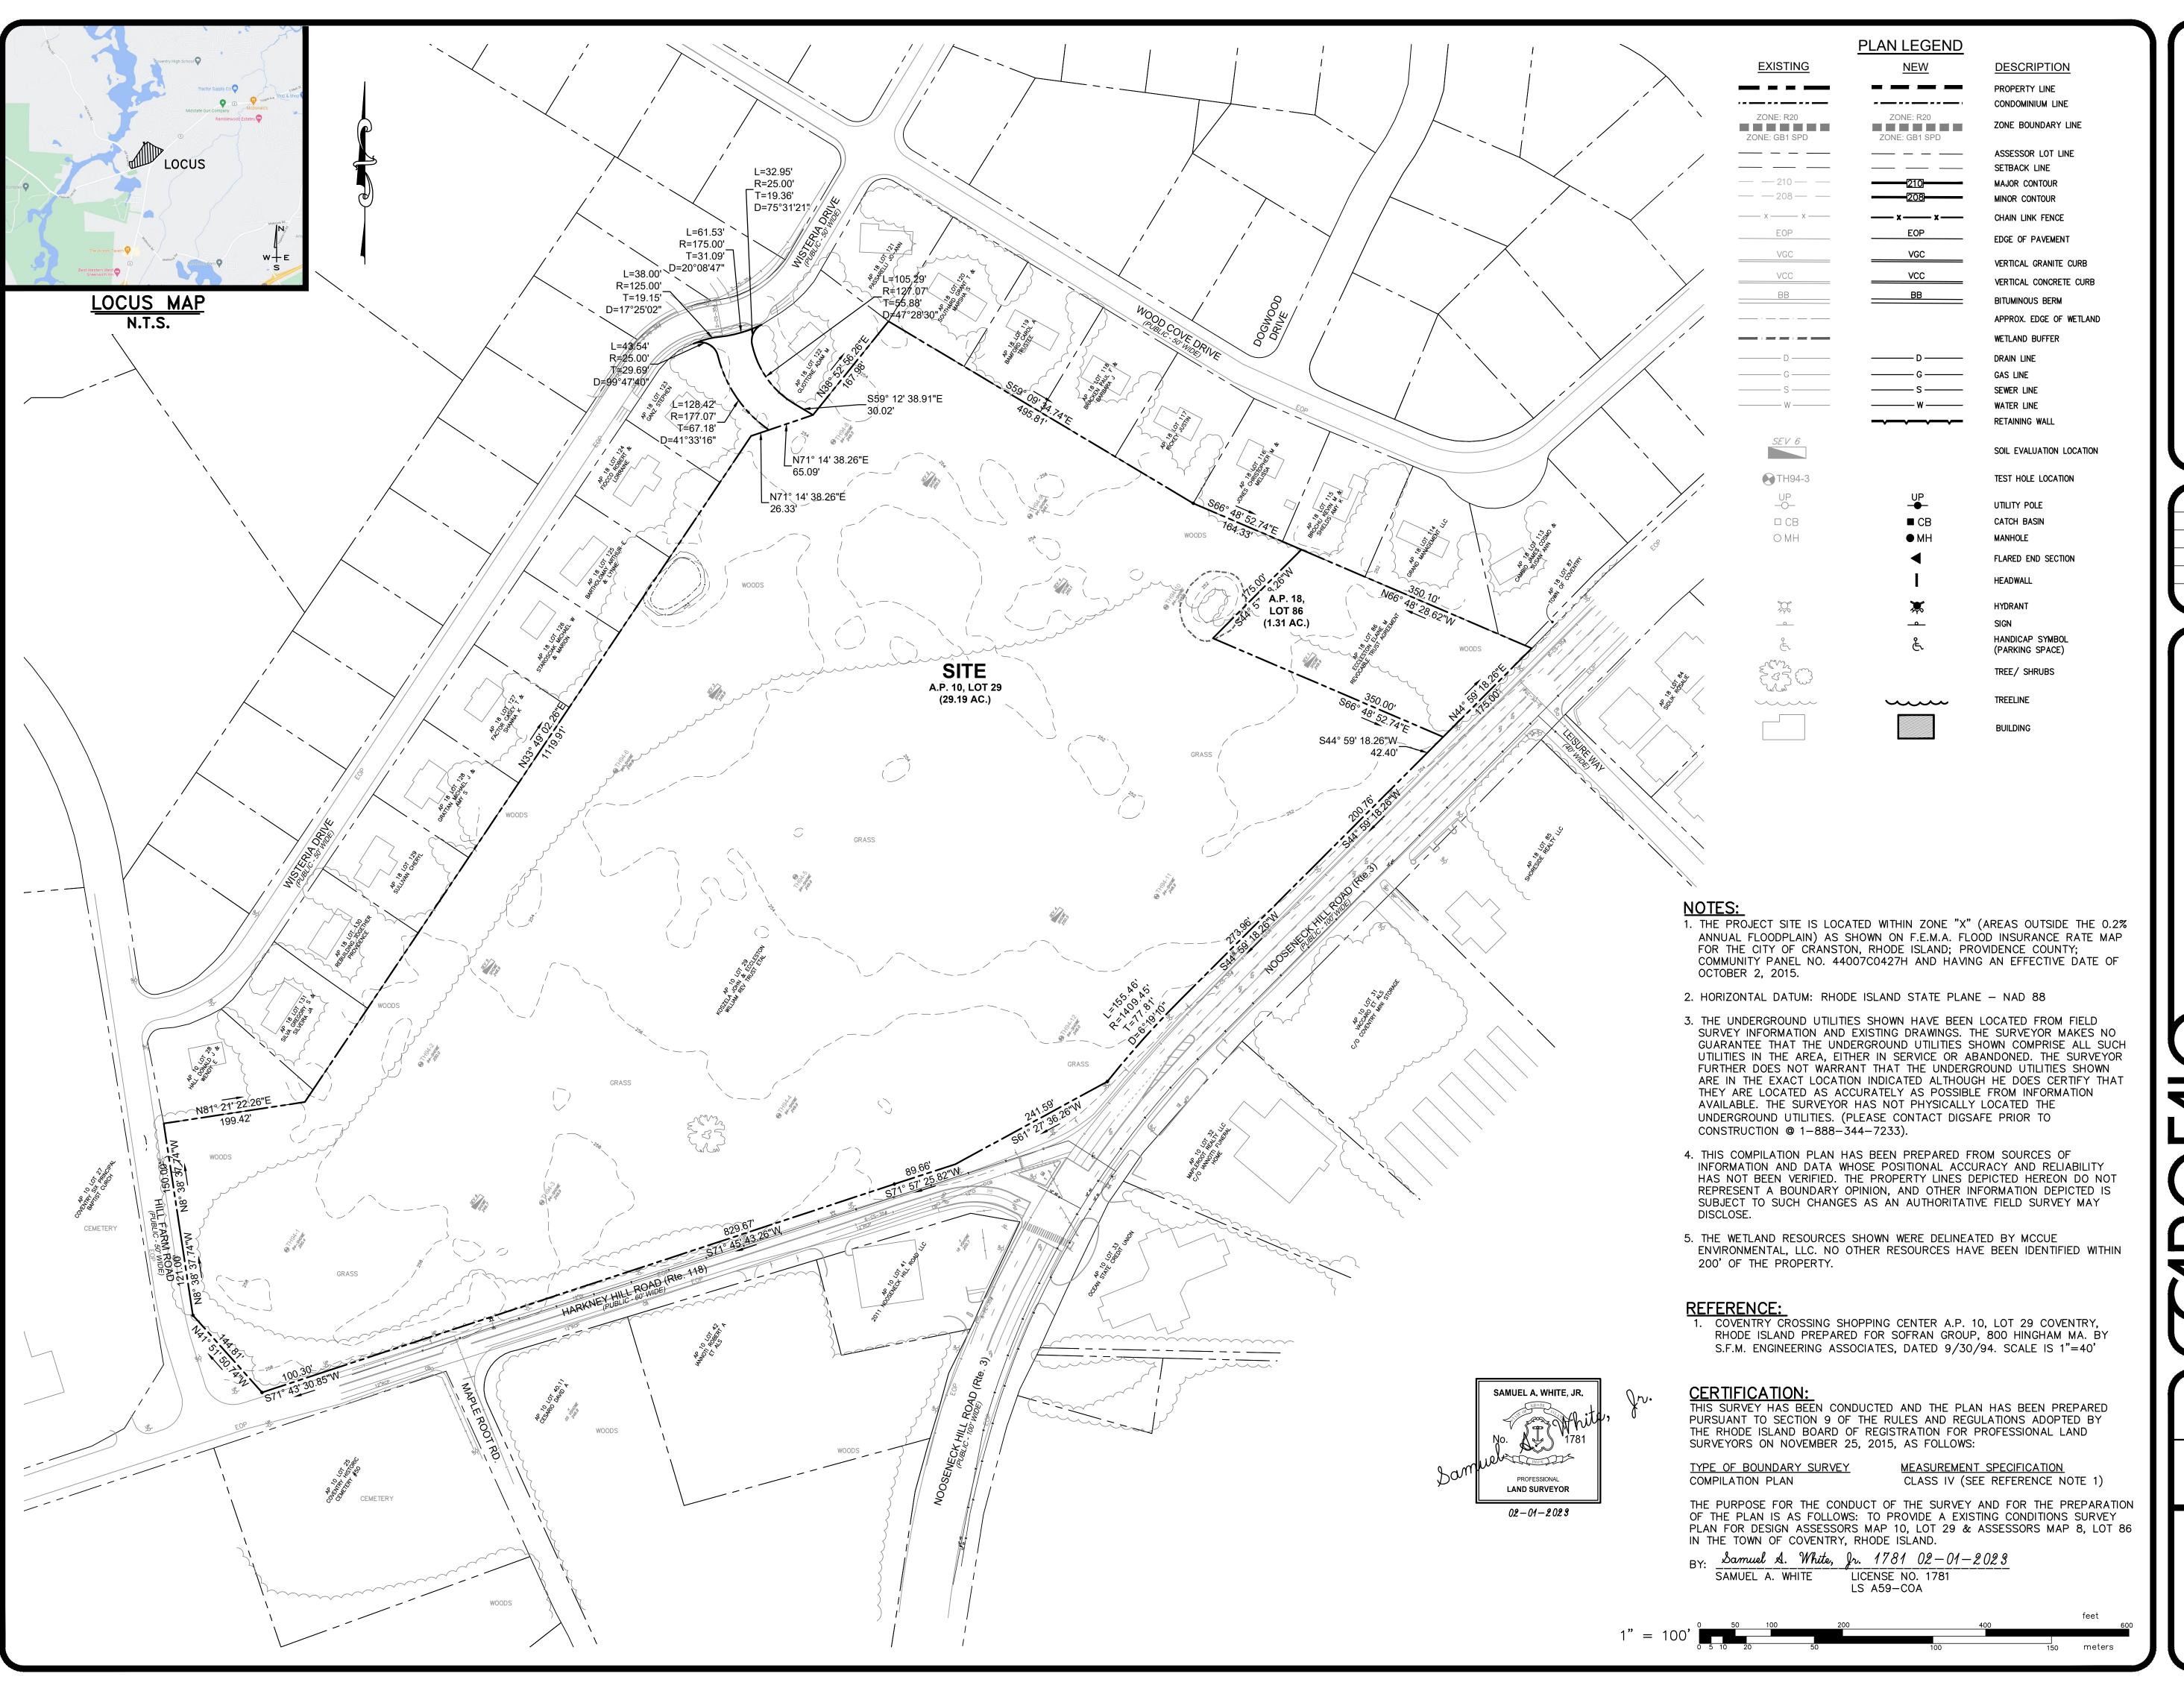

FING CONDITIONS SURVE

FOR COVENTRY CROSSINGS

P.10, LOT 29 & A.P.18 LOT 86)

SITUATED AT
HARKNEY HILL ROAD

COVENTRY, RI
PREPARED FOR
KREG NEW HOMES LLC

| NO. | REVISION | BY | DATE |
|-----|----------|----|------|
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| | | | |
| | | | |

35 CORLISS STREET
9.0. BOX 6145
9.ROVIDENCE, R.I. 02940
TEL. 401-273-6000

AUGUST, 2023

| JOB NO. 7398-00 DWG. NO. | DRAWN BY | K.J.A. |
|--------------------------------|----------|--------|
| 7398-00_MP Base ECS & SESC | CHECK BY | S.S.H. |
| SCALE: | APPROVED | S.B.G. |
| AS SHOWN | DATE: | |

SHEET

ECS

GENERAL CONSTRUCTION NOTES:

- AN APPROVED SET OF PLANS AND ALL APPLICABLE PERMITS MUST BE AVAILABLE AT THE CONSTRUCTION SITE TRAILER AT ALL TIMES. DEVIATIONS OR CHANGES WILL NOT BE ALLOWED UNLESS BY WRITTEN APPROVAL FROM THE ENGINEER.
- 2. SITEWORK CONSTRUCTION SHALL NOT COMMENCE UNTIL ALL APPROVALS FROM THE TOWN OF COVENTRY HAVE BEEN SECURED. CONTRACTOR SHALL BE RESPONSIBLE FOR PERMITS OBTAINED FOR ALL SITE WORK.
- 3. ALL IMPROVEMENTS INDICATED HEREON MUST COMPLY WITH THE 'AMERICANS WITH DISABILITIES ACT ACCESSIBILITY GUIDELINE (ADAAG)'. NOTE THAT THE DETAIL CONTAINED WITHIN THIS PLAN MAY NOT SHOW THE DETAIL NECESSARY TO CONSTRUCT WALKWAYS, RAMPS AND SPACES TO COMPLY WITH THE ADAAG REQUIREMENTS BUT THE CONTRACTOR IS RESPONSIBLE TO PROVIDE THE LEVEL OF CARE NECESSARY TO BE CERTAIN THAT THE CONSTRUCTED PRODUCT MEETS THESE STANDARDS.
- 4. THE CONTRACTOR MUST RETAIN THE SERVICES OF A REGISTERED LAND SURVEYOR IN THE STATE OF RHODE ISLAND TO LAYOUT ON THE GROUND ALL NEW ELEMENTS OF WORK. IF ANY WORK IS INSTALLED PRIOR TO THE ABOVE REQUIREMENT AND IF ANY WORK IS NOT SATISFACTORY TO THE ENGINEER, THE CONTRACTOR MUST REPLACE THE WORK AT NO ADDITIONAL COST TO THE OWNER.
- 5. THE CONTRACTOR SHALL VERIFY THE PROPOSED LAYOUT WITH ITS RELATIONSHIP TO THE EXISTING SITE SURVEY. THE CONTRACTOR SHALL VERIFY ALL DIMENSIONS, SITE CONDITIONS AND MATERIAL SPECIFICATIONS AND SHALL NOTIFY THE OWNER AND ENGINEER OF ANY ERRORS, OMISSIONS OR DISCREPANCIES BEFORE COMMENCING, INSTALLING OR PROCEEDING WITH WORK.
- 6. IT IS THE RESPONSIBILITY OF THE CONTRACTOR TO DETERMINE THE LOCATION OF ALL EXISTING UNDERGROUND UTILITIES AND TO TAKE WHATEVER NECESSARY MEASURES NEEDED TO PROVIDE FOR THEIR PROTECTION. THE ENGINEER HAS DILIGENTLY ATTEMPTED TO LOCATE AND INDICATE ALL EXISTING UNDERGROUND UTILITIES AND FACILITIES ON THE DRAWINGS; HOWEVER, THE INFORMATION SHOWN IS FOR THE CONTRACTORS CONVENIENCE ONLY. THE ENGINEER ASSUMES NO RESPONSIBILITY FOR THE LOCATIONS OF UTILITIES SHOWN OR NOT SHOWN. THE CONTRACTOR SHALL MAKE EXPLORATORY EXCAVATIONS AND LOCATE ANY EXISTING UTILITIES SUFFICIENTLY AHEAD OF CONSTRUCTION, VERIFY ALL DIMENSIONS, SITE CONDITIONS AND MATERIALS. THE CONTRACTOR MUST CONTACT THE LOCAL UTILITY COMPANIES FOR EXACT LOCATION OF UTILITIES PRIOR TO THE START OF ANY CONSTRUCTION AND SHALL NOTIFY THE ENGINEER OF ANY DISCREPANCIES BEFORE START OF ANY WORK. IT IS THE SOLE RESPONSIBILITY OF THE CONTRACTOR TO REPAIR AND REPLACE ANY AND ALL DAMAGE MADE TO UTILITIES BY THE CONTRACTOR.
- THE CONTRACTOR MUST NOTIFY OPERATORS WHO MAINTAIN UNDERGROUND UTILITIES IN THE AREA OF PROPOSED CONSTRUCTION, EXCAVATION OR BLASTING AT LEAST THREE WORKING DAYS, BUT NOT MORE THAN TEN WORKING DAYS PRIOR TO THE START OF ANY CONSTRUCTION, EXCAVATION OR BLASTING. ALL WATER, SEWER, GAS AND ALL OTHER UTILITIES MUST BE MAINTAINED AT ALL TIMES DURING CONSTRUCTION.
- 8. METHODS AND MATERIALS USED IN THE CONSTRUCTION OF IMPROVEMENTS MUST CONFORM TO THE TOWN OF COVENTRY CURRENT CONSTRUCTION STANDARDS AND SPECIFICATIONS AND THE STATE OF RHODE ISLAND DEPARTMENT OF TRANSPORTATION. THE STATE OF RHODE ISLAND STANDARD SPECIFICATIONS FOR ROAD AND BRIDGE CONSTRUCTION, 2004 EDITION, AS AMENDED, AND THE RHODE ISLAND STANDARD DETAILS ARE MADE A PART HEREOF, AS IF ATTACHED HERETO.
- 9. THE CONTRACTOR IS RESPONSIBLE FOR REPLACING ANY PAVEMENT, DRIVEWAYS, SIDEWALKS, WALL, CURBS, ETC. DAMAGED DURING CONSTRUCTION WITH MATCHING MATERIALS.
- 10. THE CONTRACTOR AGREES THAT HE WILL ASSUME SOLE AND COMPLETE RESPONSIBILITY FOR THE PROJECT SITE CONDITIONS THROUGHOUT CONSTRUCTION INCLUDING SAFETY OF ALL PERSONS AND PROPERTY. THIS REQUIREMENT WILL APPLY CONTINUOUSLY AND NOT BE LIMITED TO NORMAL WORKING HOURS AND THAT THE CONTRACTOR SHALL DEFEND, INDEMNIFY AND HOLD THE OWNER AND THE ENGINEER HARMLESS FROM ANY AND ALL LIABILITY, REAL OR ALLEGED IN CONJUNCTION WITH THE PERFORMANCE OF WORK ON THIS PROJECT.
- 11. ALL MATERIALS USED FOR CONSTRUCTION MUST BE NEW AND FREE OF DEFECTS. USED OR SALVAGED MATERIAL WILL NOT BE ALLOWED UNLESS WRITTEN APPROVAL FROM THE OWNER IS OBTAINED BY THE CONTRACTOR.
- 12. AT ALL TIMES THE CONTRACTOR MUST MAINTAIN ACCESS FOR EMERGENCY VEHICLES AROUND AND TO ALL BUILDINGS. (I.E. IN TIMES OF RAIN OR SNOW, ROADS MUST BE ABLE TO CARRY A FIRE TRUCK BY BEING PAVED OR HAVING A CRUSHED STONE BASE, ETC.). WIDTH OF EMERGENCY VEHICLE ACCESS MUST BE A MINIMUM OF 20 FEET WIDE. ACCESS TO BUILDINGS THAT HAVE A FIRE SPRINKLER SYSTEM OR STANDPIPE MUST BE WITHIN 40 FEET OF THE FIRE DEPARTMENT CONNECTION (FDC). NFPA 1141 3-1.
- 13. NECESSARY BARRICADES, LIGHTS, SIGNS AND OTHER TRAFFIC CONTROL METHODS AS MAY BE NECESSARY FOR THE PROTECTION AND SAFETY OF THE PUBLIC MUST BE PROVIDED AND MAINTAINED THROUGHOUT CONSTRUCTION BY THE CONTRACTOR.
- 14. HIGH INTENSITY LIGHTING FACILITIES MUST BE SO ARRANGED THAT THE SOURCE OF ANY LIGHT IS CONCEALED FROM PUBLIC VIEW AND FROM ADJACENT RESIDENTIAL PROPERTY AND DOES NOT INTERFERE
- 15. ALL RI HIGHWAY BOUNDS AND PERMANENT SURVEY MARKERS SHALL BE PROTECTED THROUGHOUT CONSTRUCTION.
- 16. ALL TRAFFIC CONTROL SHALL CONFORM TO THE MANUAL ON UNIFORM TRAFFIC CONTROL DEVICES 2009
- 17. REFER TO ARCHITECTURAL, STRUCTURAL, AND MECHANICAL PLANS FOR ALL BUILDING INFORMATION, AND FOR SITEWORK WITHIN 5'-0" OF BUILDING.
- 18. ALL CURB RADII ARE 3' UNLESS OTHERWISE NOTED ON THE SITE PLAN.

INCLUDING ALL REVISIONS.

- 19. PRIOR TO THE START OF CONSTRUCTION THE CONTRACTOR IS REQUIRED TO DEVELOP AND IMPLEMENT A PLAN FOR THE TEMPORARY CONTROL OF VEHICULAR AND PEDESTRIAN TRAFFIC FOR WORK WITHIN PUBLIC STREET RIGHT-OF-WAY AT THE SITE EGRESS. CONTRACTOR SHALL OBTAIN APPROVAL OF SAID PLAN FROM APPROPRIATE STATE AND COMMUNITY PUBLIC SAFETY OFFICIALS.
- 20. WHEN IT IS NECESSARY TO CLOSE OFF A STREET, THE FIRE DEPARTMENT AND POLICE DEPARTMENT SHALL BE NOTIFIED BY THE CONTRACTOR.
- 21. SHOP DRAWINGS OF PRECAST STRUCTURES SHALL BE REVIEWED BY THE ENGINEER AND APPROVED BEFORE USE.
- 22. IF ANY EXISTING STRUCTURES AND/OR UTILITIES TO REMAIN ARE DAMAGED DURING CONSTRUCTION. EITHER ON THE PROJECT SITE, ADJACENT PROPERTIES, OR WITHIN STATE RIGHT-OF-WAY, IT SHALL BE THE CONTRACTORS RESPONSIBILITY TO REPAIR AND/OR REPLACE THE EXISTING STRUCTURE AS NECESSARY TO RETURN IT TO EXISTING CONDITIONS OR BETTER.
- 23. ALL WORK TO BE DONE WITHIN THE STATE RIGHT OF WAY (ROW) SHALL CONFORM TO THE RHODE ISLAND STANDARD SPECIFICATIONS FOR ROAD AND BRIDGE CONSTRUCTION. 2004 EDITION (AMENDED MARCH 2018) WITH ALL REVISIONS AND ADDENDA. STANDARD DETAILS FOR THIS WORK ARE R.I. STANDARD DETAILS 1998 EDITION (AMENDED JUNE 2019) WITH ALL REVISIONS.
- 24. ALL TRAFFIC CONTROL SHALL CONFORM TO THE MANUAL ON UNIFORM TRAFFIC CONTROL DEVICES (MUTCD), 2009 EDITION, INCLUDING ALL REVISIONS.

GENERAL UTILITY NOTES:

- 1. THE CONTRACTOR SHALL NOTIFY DIG-SAFE (1-888-344-7233) AND ALL LOCAL AUTHORITIES & UTILITY COMPANIES TO VERIFY LOCATIONS OF UTILITIES WITHIN THE AREA 72 HOURS PRIOR TO BEGINNING ANY EXCAVATION OR DEMOLITION FOR THE PURPOSE OF COORDINATING THE MARKING OF UNDERGROUND UTILITIES. LOCATION AND DEPTHS OF EXISTING UTILITIES SHOWN ARE APPROXIMATE ONLY. THE CONTRACTOR SHALL BE RESPONSIBLE TO VERIFY, LOCATE AND PROTECT EXISTING UTILITIES IN THE FIELD WHETHER OR NOT SHOWN ON THE DRAWINGS.
- ALL WORK SHALL BE IN COMPLETE ACCORDANCE WITH ALL APPLICABLE STATE. FEDERAL AND LOCAL CODES, AND ALL NECESSARY LICENSES AND PERMITS SHALL BE OBTAINED BY THE CONTRACTOR AT HIS EXPENSE UNLESS PREVIOUSLY OBTAINED BY THE OWNER/DEVELOPER.
- 3. THE CONTRACTOR SHALL COORDINATE LOCATION AND INSTALLATION OF ALL UNDERGROUND UTILITIES AND APPURTENANCES TO MINIMIZE DISTURBANCE OF CURBING, PAVING AND COMPACTED SUBGRADE. THE CONTRACTOR SHALL NOTIFY THE TOWN ENGINEER & ALL LOCAL UTILITY COMPANIES 48 HOURS BEFORE EACH PHASE OF CONSTRUCTION. THE CONTRACTOR SHALL IMMEDIATELY INFORM THE ENGINEER OF ANY DISCREPANCIES OR ERRORS DISCOVERED IN THE PLANS.
- 4. BEDDING REQUIREMENTS SPECIFIED HEREIN ARE TO BE CONSIDERED AS MINIMUMS FOR RELATIVELY DRY, STABLE EARTH CONDITIONS. ADDITIONAL BEDDING SHALL BE REQUIRED FOR ROCK TRENCHES AND WET AREA. CONTRACTOR SHALL HAVE THE RESPONSIBILITY TO PROVIDE SUCH ADDITIONAL BEDDING AS MAY BE REQUIRED TO PROPERLY CONSTRUCT THE WORK.
- 5. THE CONTRACTOR SHALL REMOVE ANY ABANDONED FOUNDATIONS, UTILITY STRUCTURES, BURIED DEBRIS ETC. WHICH INTERFERE WITH THE INSTALLATION OF THE UTILITY WORK. ALL SUCH STRUCTURES SHALL BE COMPLETELY REMOVED AND THE EXCAVATED AREA SHALL BE BACKFILLED WITH COMPACTED GRAVEL IN 6" LIFTS TO 95% COMPACTION TO 6" BELOW THE BOTTOM OF THE UTILITY AND PIPE.
- COMPACTION OF THE BACKFILL OF ALL TRENCHES SHALL BE COMPACTED TO THE DENSITY OF 95% OF THE THEORETICAL MAXIMUM DRY DENSITY (ASTM D698). BACKFILL MATERIAL SHALL BE FREE FROM ROOTS, STUMPS OR OTHER FOREIGN DEBRIS AND SHALL BE PLACED IN LIFTS NOT TO EXCEED ONE FOOT IN COMPACTED FILL THICKNESS. CORRECTION OF ANY TRENCH SETTLEMENT WITHIN A YEAR FROM THE DATE OF PROJECT APPROVAL WILL BE THE RESPONSIBILITY OF THE CONTRACTOR.
- 7. ALL PIPING LAYOUT INDICATED ON THESE PLANS IS DIAGRAMMATIC ONLY AND DOES NOT SHOW ALL THE REQUIRED FITTINGS FOR PROPER ALIGNMENT. THE CONTRACTOR SHALL PROVIDE ALL REQUIRED FITTINGS TO OBTAIN PROPER ALIGNMENT AND FOR EXISTING UTILITY CONNECTIONS BASED UPON FIELD CONDITIONS.
- 8. IF DURING EXCAVATION THE TRENCH WIDTH EXCEEDS THE SUM OF THE PIPE O.D. PLUS 2'-0", PLACE AND COMPACT THE FILL TO 12" ABOVE THE PIPE AND RE-EXCAVATE TO REQUIRED GRADE.
- 9. STORM DRAINS 12" AND OVER SHALL BE SMOOTH INTERIOR WALL AND EXTERIOR CORRUGATED HIGH DENSITY POLYETHYLENE (HDPE) PIPE CAPABLE OF WITHSTANDING (H-20) LOAD UNLESS NOTED OTHERWISE. PIPE SHALL BE JOINED USING BELL & SPIGOT JOINTS MEETING OR EXCEED ASTM F2648. THE JOINT SHALL BE SOIL-TIGHT AND GASKETS SHALL MEET OR EXCEED ASTM F477. HDPE PIPE SHALL BE AS MANUFACTURED BY ADVANCED DRAINAGE SYSTEMS INC. (ADS), HANCOR PIPE OR LANE PIPE. ALL STORM DRAINAGE PIPING SHALL BE LAID ON A SMOOTH CONTINUOUS GRADE WITH NO VISIBLE BENDS AT THE JOINTS. WHERE INDICATED ON DRAWINGS REINFORCED CONCRETE PIPE (RCP) PIPE SHALL BE CLASS III RCP WITH "O" RING GASKET JOINTS. ALL STORM PIPE ENTRY STRUCTURES SHALL BE GASKETED.
- 10. DOMESTIC AND FIRE PROTECTION WATER SERVICE IS PROVIDED TO THE PROPERTY BY KENT COUNTY WATER AUTHORITY (KCWA). THE ONSITE WATER SYSTEM ON THE PROPERTY IS PRIVATE WATER PIPING AND SHALL BE (AWWA C901) DR9 POLYETHYLENE OR TYPE k COPPER FOR 2" SERVICES OR SMALLER, OR CLASS 52 DOUBLE CEMENT LINED DUCTILE IRON PIPE WITH TYTON JOINTS FOR 4" SERVICES OR LARGER. ALL BENDS, TEES ETC. SHALL BE JOINT RESTRAINED BY THE USE OF CONCRETE THRUST BLOCKS AND "MEG-A-LUG". ALL MATERIALS AND WORKMANSHIP SHALL CONFORM TO PROVIDENCE WATER REGULATIONS, STANDARDS AND SPECIFICATIONS. NOTIFICATION SHALL BE PROVIDED TO SAID AUTHORITIES AT LEAST 72 HOURS PRIOR TO INITIATING CONSTRUCTION.
- 11. GATE VALVES SHALL BE CAST IRON BODY BRONZE MOUNTED, COMPLETE WITH ROAD BOX AND SHALL CONFORM TO PROVIDENCE WATER AND TOWN OF COVENTRY REGULATIONS, STANDARDS AND SPECIFICATIONS.
- 12. ALL FIRE AND PLUMBING FIXTURES MUST CONFORM TO LOCAL SPECIFICATIONS AND AS STIPULATED BY THE LOCAL FIRE MARSHALL AND/OR THE BUILDING OFFICIAL.
- 13. ALL SANITARY SEWER MATERIALS AND WORKMANSHIP ASSOCIATED WITH THE INSTALLATION AND TESTING OF SANITARY SEWERS SHALL CONFORM TO THE NBC REGULATIONS, STANDARDS AND SPECIFICATIONS. ALL SEWER SYSTEM COMPONENTS MUST BE TESTED, CLEANED AND AS-BUILT INFORMATION MUST BE SUBMITTED TO THE NBC AND APPROVED. PRIOR TO ISSUANCE OF A PERMIT TO DISCHARGE TO THE PUBLIC SEWER SYSTEM.
- 14. SANITARY SEWER MAINS AND SERVICES SHALL BE SDR-35 (ASTM D-3034) PVC SEWER PIPE WITH PUSH ON RUBBER RING JOINTS UNLESS NOTED OTHERWISE. CLEANOUTS SHALL BE INSTALLED AT BUILDING FACE (REFER TO PLUMBING PLANS FOR ALL WORK WITHIN 5' OF THE BUILDING). NEOPRENE COUPLINGS WITH STAINLESS STEEL BAND AND SHEER RINGS SHALL BE REQUIRED FOR JOINING DIFFERENT TYPES OF SANITARY SEWER PIPES.
- 15. SEWER LINES SHALL BE INSTALLED AT A MINIMUM 10 FOOT HORIZONTAL SEPARATION FROM ANY PROPOSED OR EXISTING WATER LINE. CONTRACTOR SHALL INSTALL CLEANOUT AT THE BUILDING FACE. CONTRACTOR SHALL PERFORM ALL WORK IN ACCORDANCE WITH THE NBC REQUIREMENTS.
- 16. WHENEVER SEWER LINES MUST CROSS WATER LINES, THE SEWER SHALL BE INSTALLED SO THAT THE TOP OF THE SEWER IS AT LEAST 18 INCHES BELOW THE BOTTOM OF THE WATER MAIN. WHERE 18 INCH VERTICAL SEPARATION AND 10 FOOT HORIZONTAL SEPARATION CAN NOT BE MET AT WATER AND SEWER CROSSINGS, THE SEWER PIPE SHALL BE ENCASED IN CONCRETE OR BE EITHER DUCTILE
- 17. GAS SERVICE FACILITIES SHALL BE DESIGNED BY OTHERS. CONTRACTOR SHALL BE RESPONSIBLE TO COORDINATE UTILITY INSTALLATIONS AS REQUIRED TO ENSURE ADEQUATE GAS SERVICE IS PROVIDED AND SHALL BE RESPONSIBLE FOR ALL INSTALLATION PROCEDURES (TRENCHING, LAYING PIPE, ETC.) AS ARE REQUIRED BY THE GAS COMPANY FOR COMPLETE AND IN PLACE CONSTRUCTION.

IRON OR C900 BLUE BRUTE FOR A DISTANCE OF 10 FEET ON EACH SIDE OF CROSSING.

18. ELECTRIC SERVICE FACILITIES SHALL BE DESIGNED BY OTHERS. ELECTRIC SERVICE AND TRANSFORMER PAD SHALL CONFORM TO THE REQUIREMENTS OF THE ELECTRIC COMPANY. CONTRACTOR SHALL BE RESPONSIBLE FOR ENSURING ADEQUATE ELECTRIC SERVICE IS PROVIDED AND SHALL BE RESPONSIBLE FOR ALL INSTALLATION PROCEDURES (TRENCHING, LAYING PIPE, ETC.) AS ARE REQUIRED BY THE ELECTRIC COMPANY FOR COMPLETE AND IN PLACE CONSTRUCTION. REFER TO ELECTRICAL DRAWINGS FOR ALL UNDERGROUND ELECTRIC.

STORMWATER SYSTEM MAINTENANCE NOTES:

 THE DRAINAGE SYSTEMS ARE TO BE MONITORED THROUGHOUT THE ENTIRE CONSTRUCTION PERIOD BY THE CONTRACTOR. UPON COMPLETION OF THE PROJECT THE CONTRACTOR MUST DO A FINAL FULL MAINTENANCE & CLEAN UP OF THE STORMWATER MANAGEMENT SYSTEM AND THE SITE. UPON COMPLETION OF THE CONTRACTOR'S FINAL MAINTENANCE & CLEAN UP OF THE PROJECT, MONITORING OF THE STORMWATER MANAGEMENT SYSTEM SHALL BE THE RESPONSIBILITY OF THE OWNER.

CONSTRUCTION MONITORING/MAINTENANCE PROCEDURES SHALL BE AS FOLLOWS: (RESPONSIBILITY OF CONTRACTOR)

2. SILT BARRIER:

- MONITOR SILT BARRIER ON A WEEKLY BASIS AND AFTER EVERY RAIN STORM EVENT AND REPAIR OR REPLACE ANY DAMAGED AREAS IMMEDIATELY. IMMEDIATELY CLEAN THE SILT BARRIER IF SIX INCHES OR MORE OF SEDIMENT HAS ACCUMULATED ON THE HAYBALE & SILT BARRIER.
- PAVED AREAS: PARKING LOTS, PUBLIC & PRIVATE ROADWAYS AND GUTTERS SHALL BE SWEPT CLEAN OF ALL SEDIMENT & DEBRIS. SWEEPING & REMOVAL OF DEBRIS SHALL BE PERFORMED ON A WEEKLY BASIS AT A MINIMUM.
- 4. CATCH BASINS: ALL CATCH BASINS SHALL BE INSTALLED AS DETAILED AND INSPECTED AFTER EVERY RAIN EVENT. IMMEDIATELY CLEAN THE CATCH BASIN SUMP IF TWO FEET OR MORE OF SEDIMENT HAS ACCUMULATED WITHIN THE CATCH BASIN.
- 5. DRAIN MANHOLES: DRAIN MANHOLES SHALL BE INSTALLED AS DETAILED AND INSPECTED AFTER EVERY RAIN STORM EVENT. IMMEDIATELY CLEAN THE DRAIN MANHOLE IF ANY OF SEDIMENT HAS ACCUMULATED WITHIN THE DRAIN MANHOLE.
- STORMWATER BMPS: NO CONSTRUCTION RUNOFF SHALL BE DIRECTED TO STORMWATER BMPS UNTIL UPGRADIENT AREAS ARE STABILIZED.

POST CONSTRUCTION MONITORING/MAINTENANCE PROCEDURES SHALL BE AS FOLLOWS: (RESPONSIBILITY OF OWNER)

PAVED AREAS:

- PARKING LOTS, ROADS AND ALL ACCESS WAYS AND GUTTERS MUST BE SWEPT CLEAN OF ALL SEDIMENT AND DEBRIS ON BI-ANNUAL BASIS IN SPRING AND FALL OF EACH YEAR OR AS NECESSARY.
- 2. CATCH BASINS: ALL CATCH BASINS MUST BE INSPECTED AND MAINTAINED ON A TWICE-ANNUAL BASIS IN MARCH AND OCTOBER OF EACH YEAR. CATCH BASINS MUST BE INSPECTED TO ENSURE THEY HAVE ADEQUATE SUMP CAPACITY. FRAMES AND GRATES ARE NOT DAMAGED. AND OIL/WATER SEPARATING DEVICES ARE IN PLACE. CATCH BASIN SUMPS ARE TO BE CLEANED OUT DURING BI-ANNUAL INSPECTIONS IN MARCH AND OCTOBER OF EACH YEAR. IMMEDIATELY CLEAN THE CATCH BASIN SUMP IF TWO FEET OR MORE OF SEDIMENT HAS ACCUMULATED WITHIN THE CATCH BASIN.
- DRAIN MANHOLES: ALL DRAIN MANHOLES MUST BE INSPECTED AND MAINTAINED ON A ANNUAL BASIS IN MARCH AND OCTOBER OF EACH YEAR. DRAIN MANHOLES MUST BE INSPECTED TO ENSURE FRAMES AND COVERS ARE NOT DAMAGED AND NO BLOCKAGES HAVE OCCURRED WITHIN THE MANHOLE. DRAIN MANHOLES ARE TO BE CLEANED OUT DURING BI-ANNUAL INSPECTIONS IN MARCH AND OCTOBER OF EACH YEAR. IMMEDIATELY CLEAN THE DRAIN MANHOLE IF ANY SEDIMENT HAS ACCUMULATED.
- 4. STORMWATER MANAGEMENT FACILITIES REFER TO OPERATIONS AND MAINTENANCE PLAN UNDER SEPARATE COVER. (NOTE: A LEGALLY ENFORCEABLE MAINTENANCE AGREEMENT SHALL BE EXECUTED IF THE PROPERTY OWNER IS NOT THE PARTY RESPONSIBLE FOR BMP MAINTENANCE AS PRESCRIBED)

INFILTRATION AREA CONSTRUCTION PROTECTION

FOR THE LONG-TERM FUNCTION OF THE INFILTRATING SYSTEMS, CARE MUST BE TAKEN IN THIS AREA DURING CONSTRUCTION. THE CONTRACTOR SHALL EMPLOY THE FOLLOWING MINIMUM BEST MANAGEMENT PRACTICES

- 1. THE INFILTRATION AREAS SHALL NOT BE USED AS A CONSTRUCTION SEDIMENTATION SYSTEM
- 2. CONSTRUCTION EQUIPMENT, VEHICULAR TRAFFIC, PARKING OF VEHICLES, AND STOCKPILING OF CONSTRUCTION AND EARTH MATERIALS SHALL BE OUTSIDE THE LIMITS OF THE INFILTRATION AREA UNTIL INSTALLATION IS COMPLETED. THE SUBGRADE BENEATH THE SYSTEM SHALL NOT BE COMPACTED.
- 3. EXCAVATION FOR CONSTRUCTION OF THE INFILTRATION AREAS SHALL BE PERFORMED MANUALLY OR BY HYDRAULIC EXCAVATOR OR SOME OTHER SIMILAR MEANS TO ENSURE THAT THE EQUIPMENT IS NOT IN DIRECT CONTACT WITH THE NATURAL INFILTRATION EARTH MATERIAL AND DOES NOT CAUSE COMPACTION OF THE MATERIAL AND THE ENTIRE AREA IS TO BE SCARIFIED PRIOR TO INSTALLATION.
- 4. THE CONTRACTOR SHALL INSTALL TEMPORARY CONSTRUCTION FENCING AND EROSION CONTROLS AROUND THE PERIMETER OF THE INFILTRATION AREA TO PREVENT THE USE OF THIS AREA FOR ALL ACTIVITIES THAT MIGHT DAMAGE THE INFILTRATION CAPABILITIES OF THE AREA. THIS FENCING MAY BE REMOVED FOR BACKFILLING AND FINAL CONSTRUCTION.

GENERAL GRADING NOTES:

- THE MAXIMUM RUNNING SLOPE ALONG ANY SIDEWALK SHALL BE 5%. THE MAXIMUM CROSS SLOPE ACROSS ANY SIDEWALK SHALL BE 2%. A MINIMUM 5'x5' LANDING SHALL BE PROVIDED IN FRONT OF ALL BUILDING ENTRANCES.
- 2. ALL ADAAG PARKING SAPCES AND LOADING SPACES SHALL BE 2% MAXIMUM SLOPE IN ANY DIRECTION.
- CONTRACTOR SHALL ASSURE POSITIVE DRAINAGE AWAY FROM BUILDINGS FOR ALL NATURAL AND PAVED
- 4. ALL GRATES AND COVERS IN PAVED AREAS SHALL BE FLUSH WITH PAVEMENT, AND SHALL HAVE TRAFFIC BEARING RING & COVERS. MANHOLES IN UNPAVED AREAS SHALL BE 3" ABOVE FINISH GRADE.
- CONTRACTOR SHALL ADJUST AND/OR CUT EXISTING PAVEMENT AS NECESSARY TO ASSURE A SMOOTH FIT AND CONTINUOUS GRADE.
- ALL UNSURFACED AREAS DISTURBED BY GRADING OPERATION SHALL RECEIVE 4 INCHES OF TOPSOIL. CONTRACTOR SHALL APPLY STABILIZATION FABRIC TO ALL SLOPES 3H:1V OR STEEPER. CONTRACTOR SHALL GRASS DISTURBED AREAS IN ACCORDANCE WITH THE CITY OF PROVIDENCE SPECIFICATIONS UNTIL A HEALTHY STAND OF GRASS IS OBTAINED.

SITE LEGEND

NEW

DESCRIPTION

EXISTING

—⊗——⊗—

 $-\Box$

| <u>Q</u> | <u> </u> | CENTERLINE (LAYOUT) |
|---|---|--|
| D | D | STORM DRAIN |
| —— E ——— | E | ELECTRIC (UNDERGROUND) |
| F | F —— | FIRE SERVICE |
| —— FD ——— ——— G ———— | —— FD ————————————————————————————————— | FOOTING DRAIN GAS |
| —— OHW ——— | —— онw—— | OVERHEAD WIRE |
| | —————————————————————————————————————— | PROPERTY LINE |
| s | s | SANITARY SEWER |
| —— SL ——— | SL | SITE LIGHTING SERVICE |
| T | T | TELEPHONE |
| W | w | WATER |
| | | |
| 64 | 64 | CONTOUR |
| × 64.0 | × 64.00 | SPOT GRADE |
| × 64.0(BC) | x 64.00(BC) | SPOT GRADE (BOT. OF CURB) |
| × 64.5(TC) | × 64.50(TC) | SPOT GRADE (TOP OF CURB) |
| 64.5(BW) | 64.50(BW) | SPOT GRADE (BOT. OF WALL) |
| 64.5(TW) | 64.50(TW) | SPOT GRADE (TOP OF WALL) |
| | | PRECAST CONC. CURB |
| CC | PCC | CHAINLINK FENCE (CLF) |
| or 100 100 100 100 100 100 100 100 100 10 | | • • |
| | | STOCKADE FENCE (STKF) |
| • | ♦ | BORING LOCATION |
| □ CB | (Ⅲ) CB#1 | CATCH BASIN |
| | <u> </u> | |
| CB(DG) | CBDG#1 | DOUBLE GRATE CATCH BASIN |
| CTB ⊳ | CTB ⊳ | CONCRETE THRUST BLOCK |
| | 0 | DRAIN MANHOLE |
| DMH | DMH | |
| \triangleleft | ◀ | FLARED END STRUCTURE |
| FES | FES | |
| (\$) | S | SEWER MANHOLE |
| SMH | SMH | WATER SERVICE |
| * So | *8 | |
| | Q | UTILITY POLE |
| HYD | × | FIRE HYDRANT |
| M GV | ⊠ GV | GATE VALVE AND CURB BOX |
| | | HANDIOAD CYARDOL (DDVO CDAOE) |
| Ĕ. | گِ | HANDICAP SYMBOL (PRKG. SPACE) |
| | | SIGN |
| <u>11/1/2</u> | <u>11/12</u> | WETLAND |
| SEV | S EV | SOIL EVALUATION LOCATION |
| | = | TEST PIT LOCATION |
| TP | TP | lest FIT LOCATION |
| | > FDC | FIRE DEPARTMENT CONNECTION |
| • | • | |
| PIV | N PIV | POST INDICATOR VALVE (PIV) |
| E | Œ | ELECTRIC MANHOLE (EMH) |
| \bigcirc | | TELEPHONE MANHOLE (TMH) |
| | | TRANSFORMER PAD |
| T | T | |
| GEN | GEN | GENERATOR PAD |
| ⊖GCO | ⊖GCO | GROUND CLEANOUT |
| ☆ LP | •- | SIGHT LIGHT POLE |
| | \Rightarrow | TRAFFIC FLOW DIRECTION |
| | LOD | LIMIT OF DISTURBANCE |
| | 200 | |
| | | COMPOST SILT SOCKS |
| | 777//7777//7777//777 | PAVEMENT SAWCUT & MATCH TO EXISTING |
| | (X.X.X.) | RIDOT STD DETAIL REFERENCE |
| | | |
| | | CANOPY TREE |
| | | |
| | \bigcirc | FLOWERING TREE |
| | | |
| | White Section 1 | EVERGREEN TREE |
| | JAMAL. | |
| | ABBREVIATI | ONS |

CAST IRON PIPE CEMENT LINED DUCTILE IRON PIPE CHAINLINK FENCE DUCTILE IRON PIPE EXISTING FURNISH AND INSTALL INVERT ELEVATION MATCH TO EXISTING NOT IN CONTRACT NOT TO SCALE POLYVINYL CHLORIDE PIPE REINFORCED CONCRETE PIPE

6

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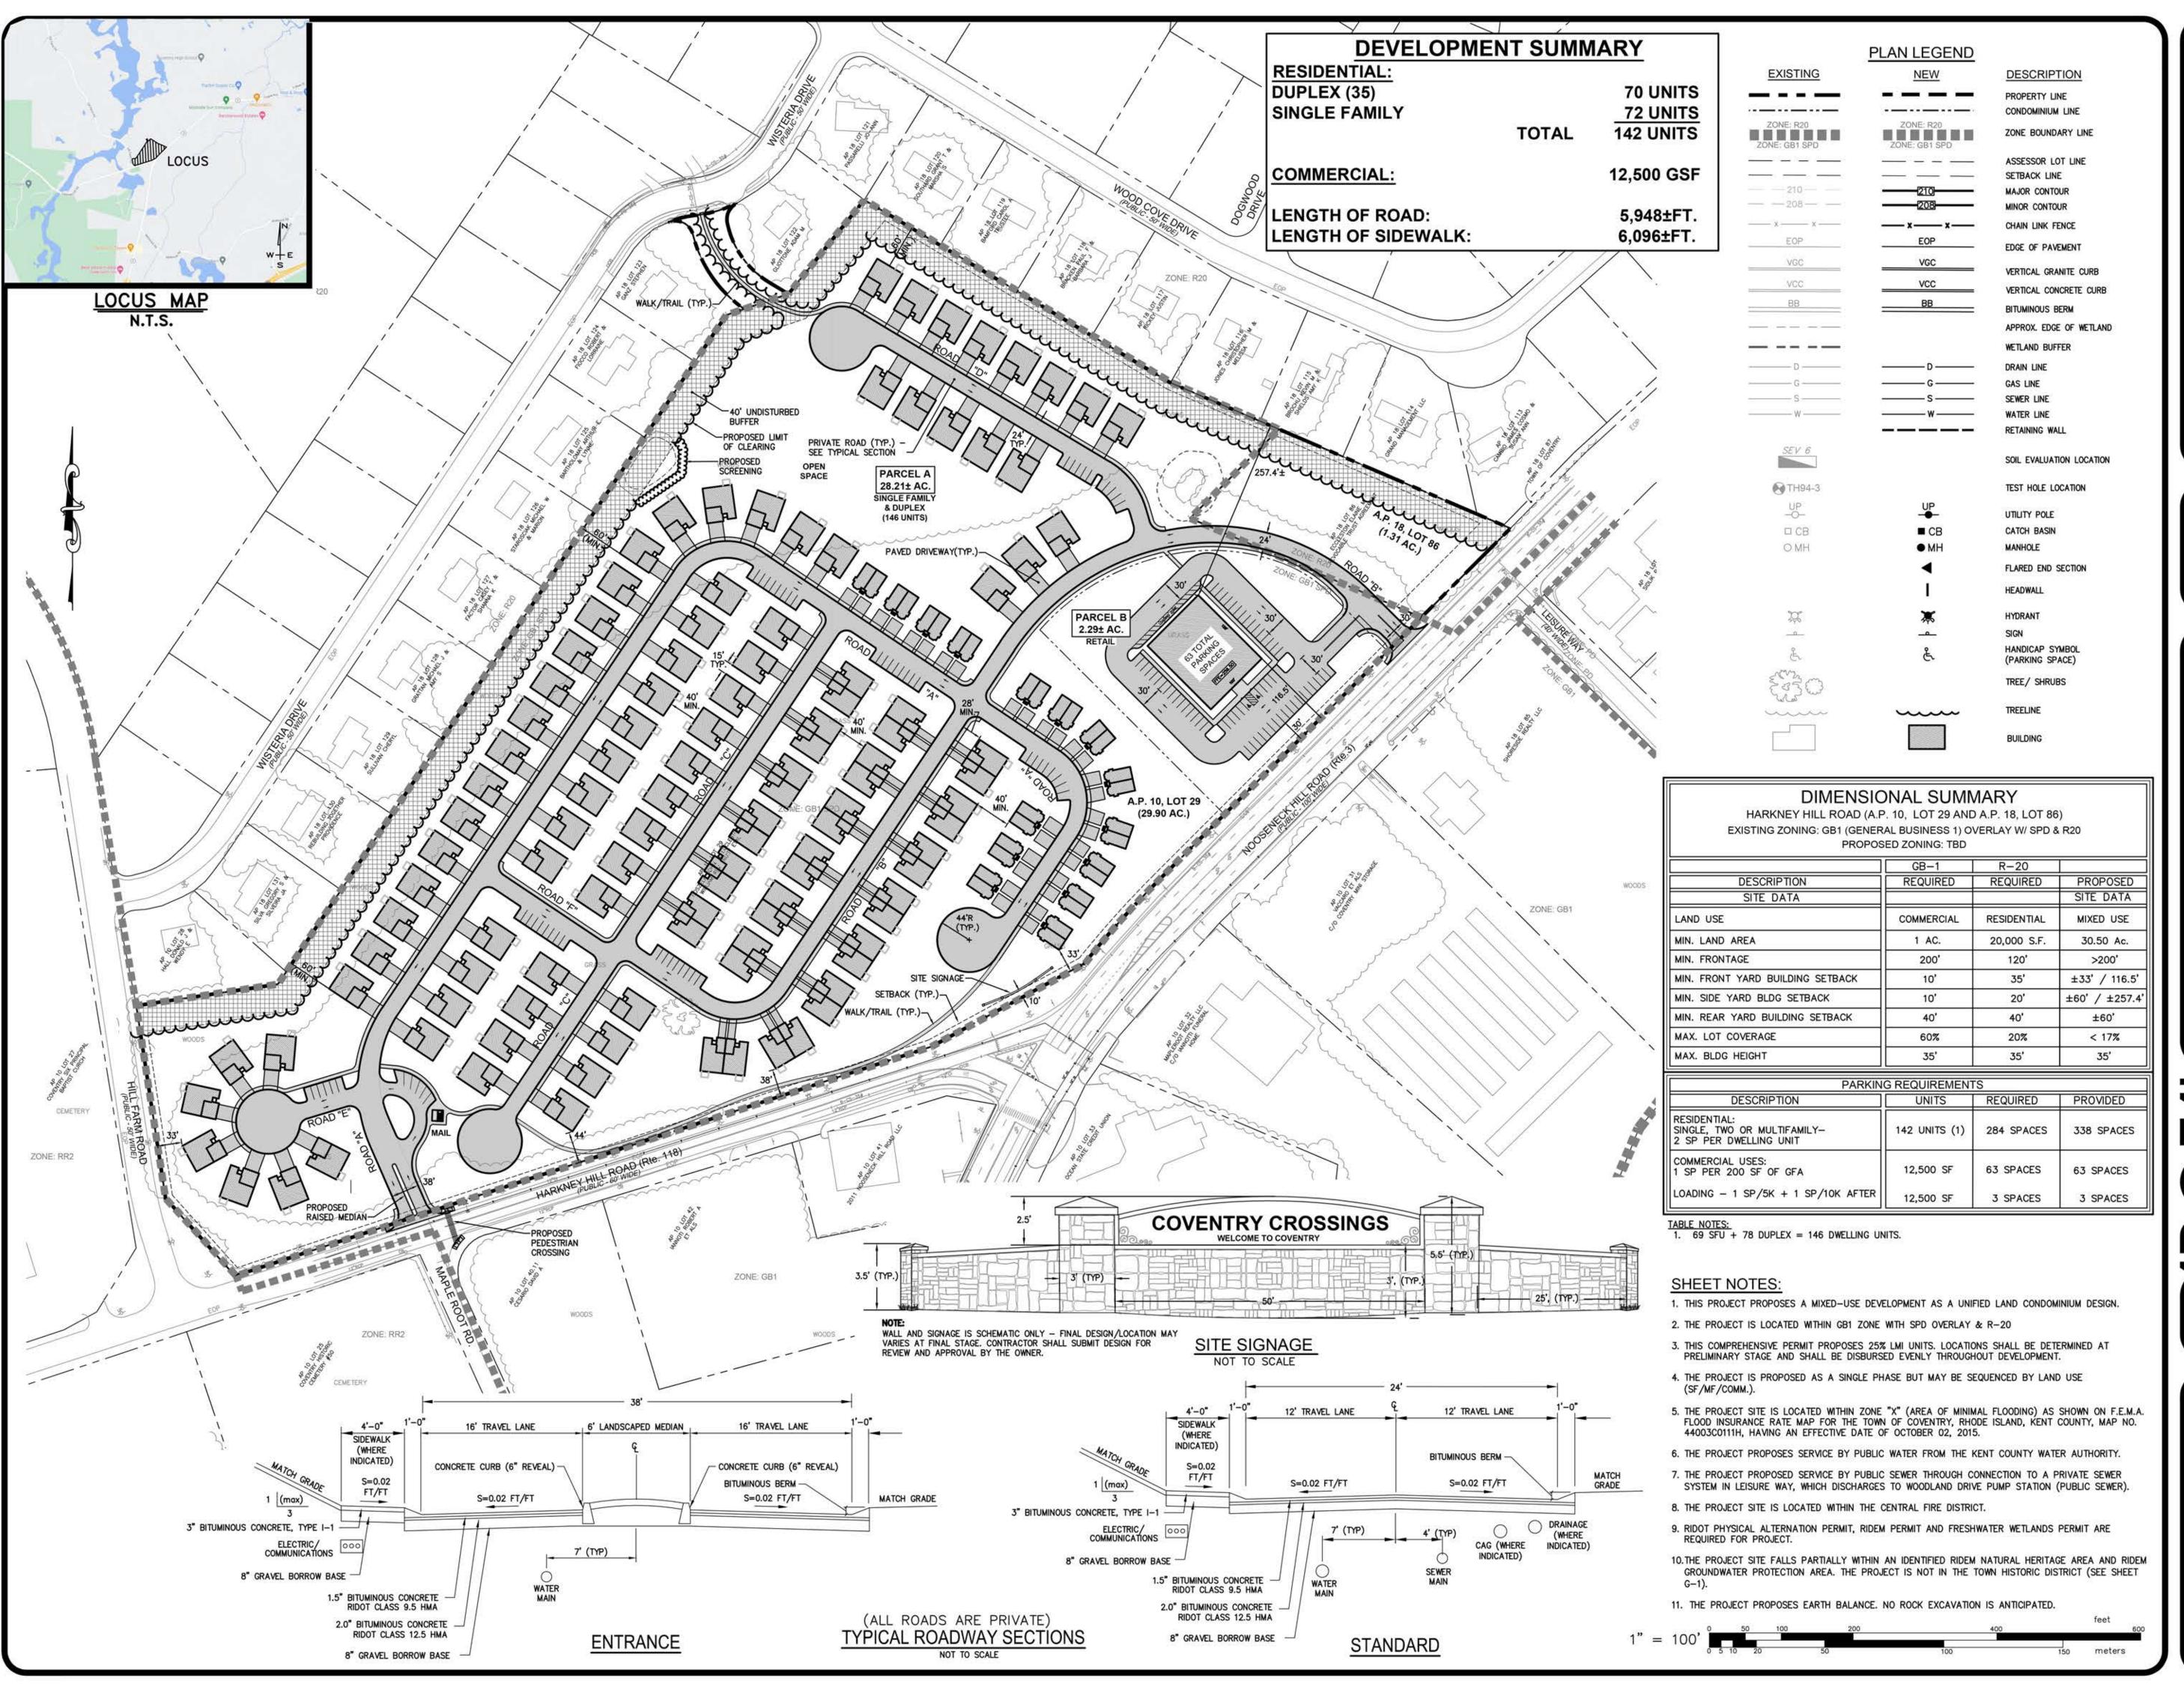
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BY DATE

REVISION

PROJECT ENGINEER **SAMUEL HEMENWAY** င် နိုင် JOB NO.

DRAWN BY K.J.A. 7398-00 DWG. NO. **CHECK BY** S.S.H. 7398-00_MP-Cover_Notes.dwg **APPROVED** S.B.G. SCALE: AS SHOWN DATE: AUGUST, 2023



| ١٥. | REVISION | BY | DATE |
|-----|-----------------------------|-----|----------|
| 1 | GENERAL LAYOUT | KJA | 7/24/23 |
| 2 | ADD EX POND/FENCE | SSH | 7/27/23 |
| 3 | MASTER PLAN REVIEW COMMENTS | KJA | 8/18/23 |
| 4 | TOWN COMMENTS | KJA | 10/06/23 |


PROJECT ENGINEER SAMUEL HEMENWAY

DRAWN BY K.J.A. 7398-00 DWG. NO.

BASE_CONCEPT 14.DWG SCALE:

CHECK BY S.S.H. APPROVED S.B.G. AUGUST, 2023

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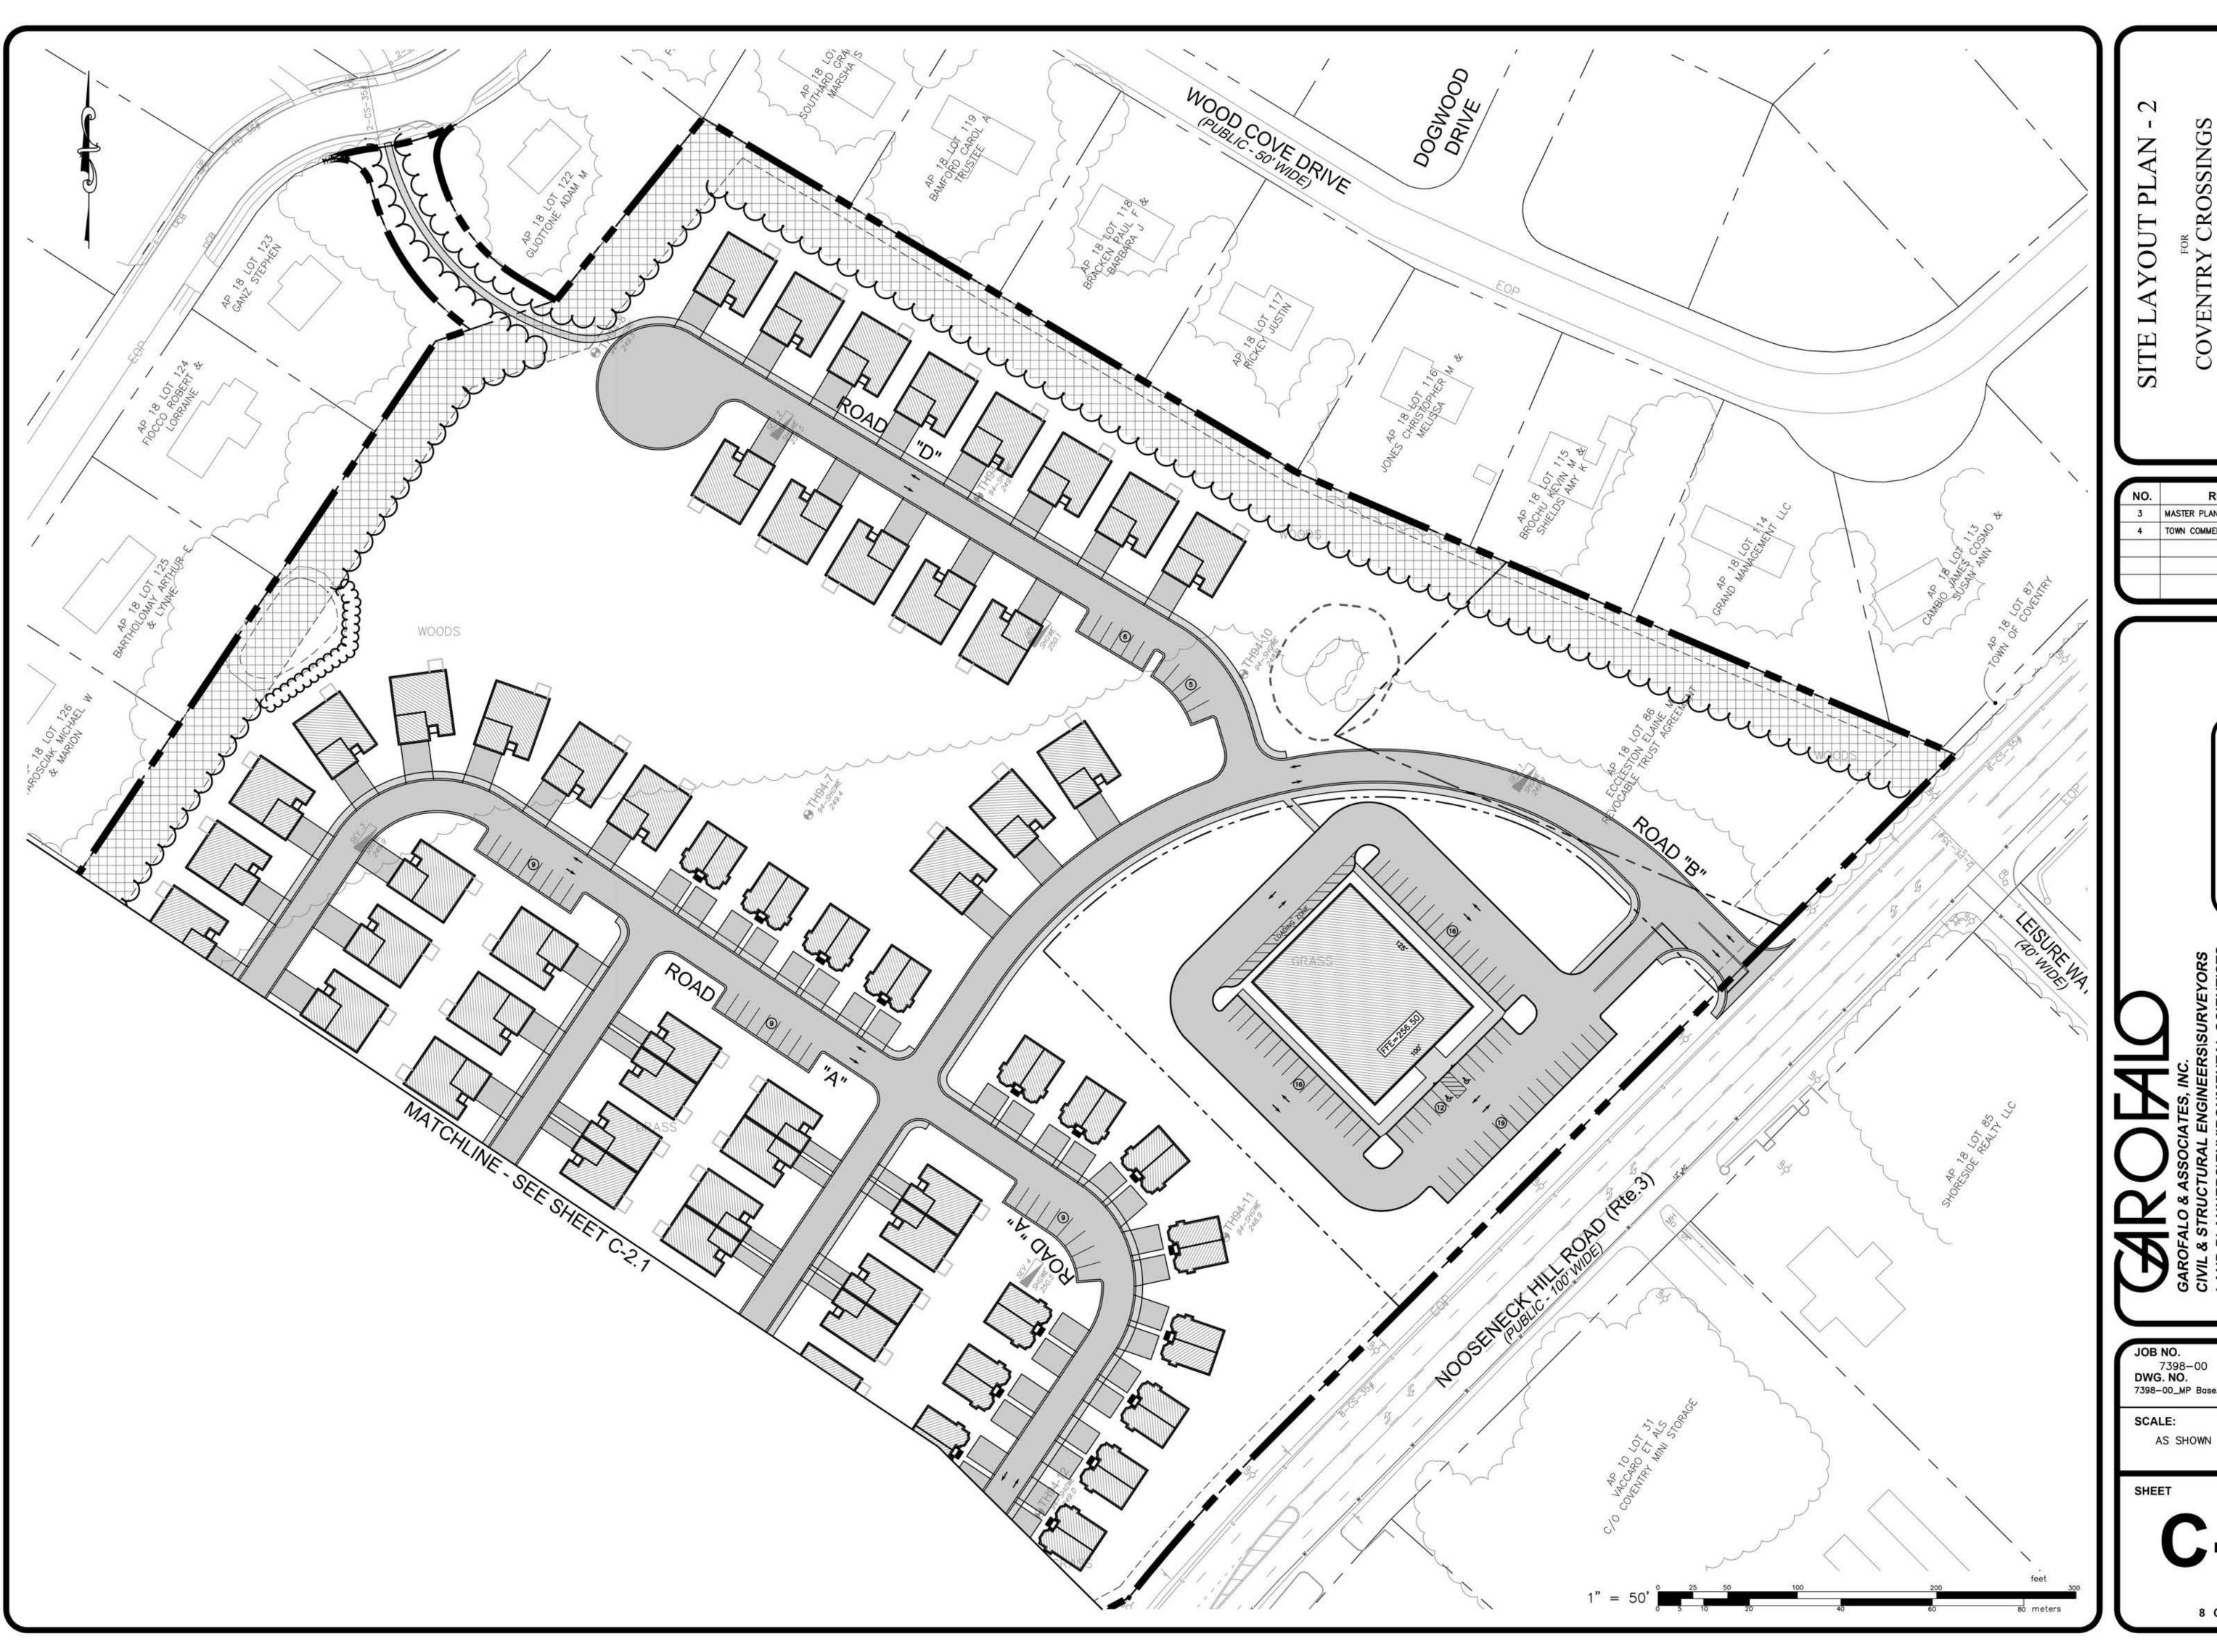
KREG NEW HOMES, LLC 39 NOOSENECK HILLE ROAD
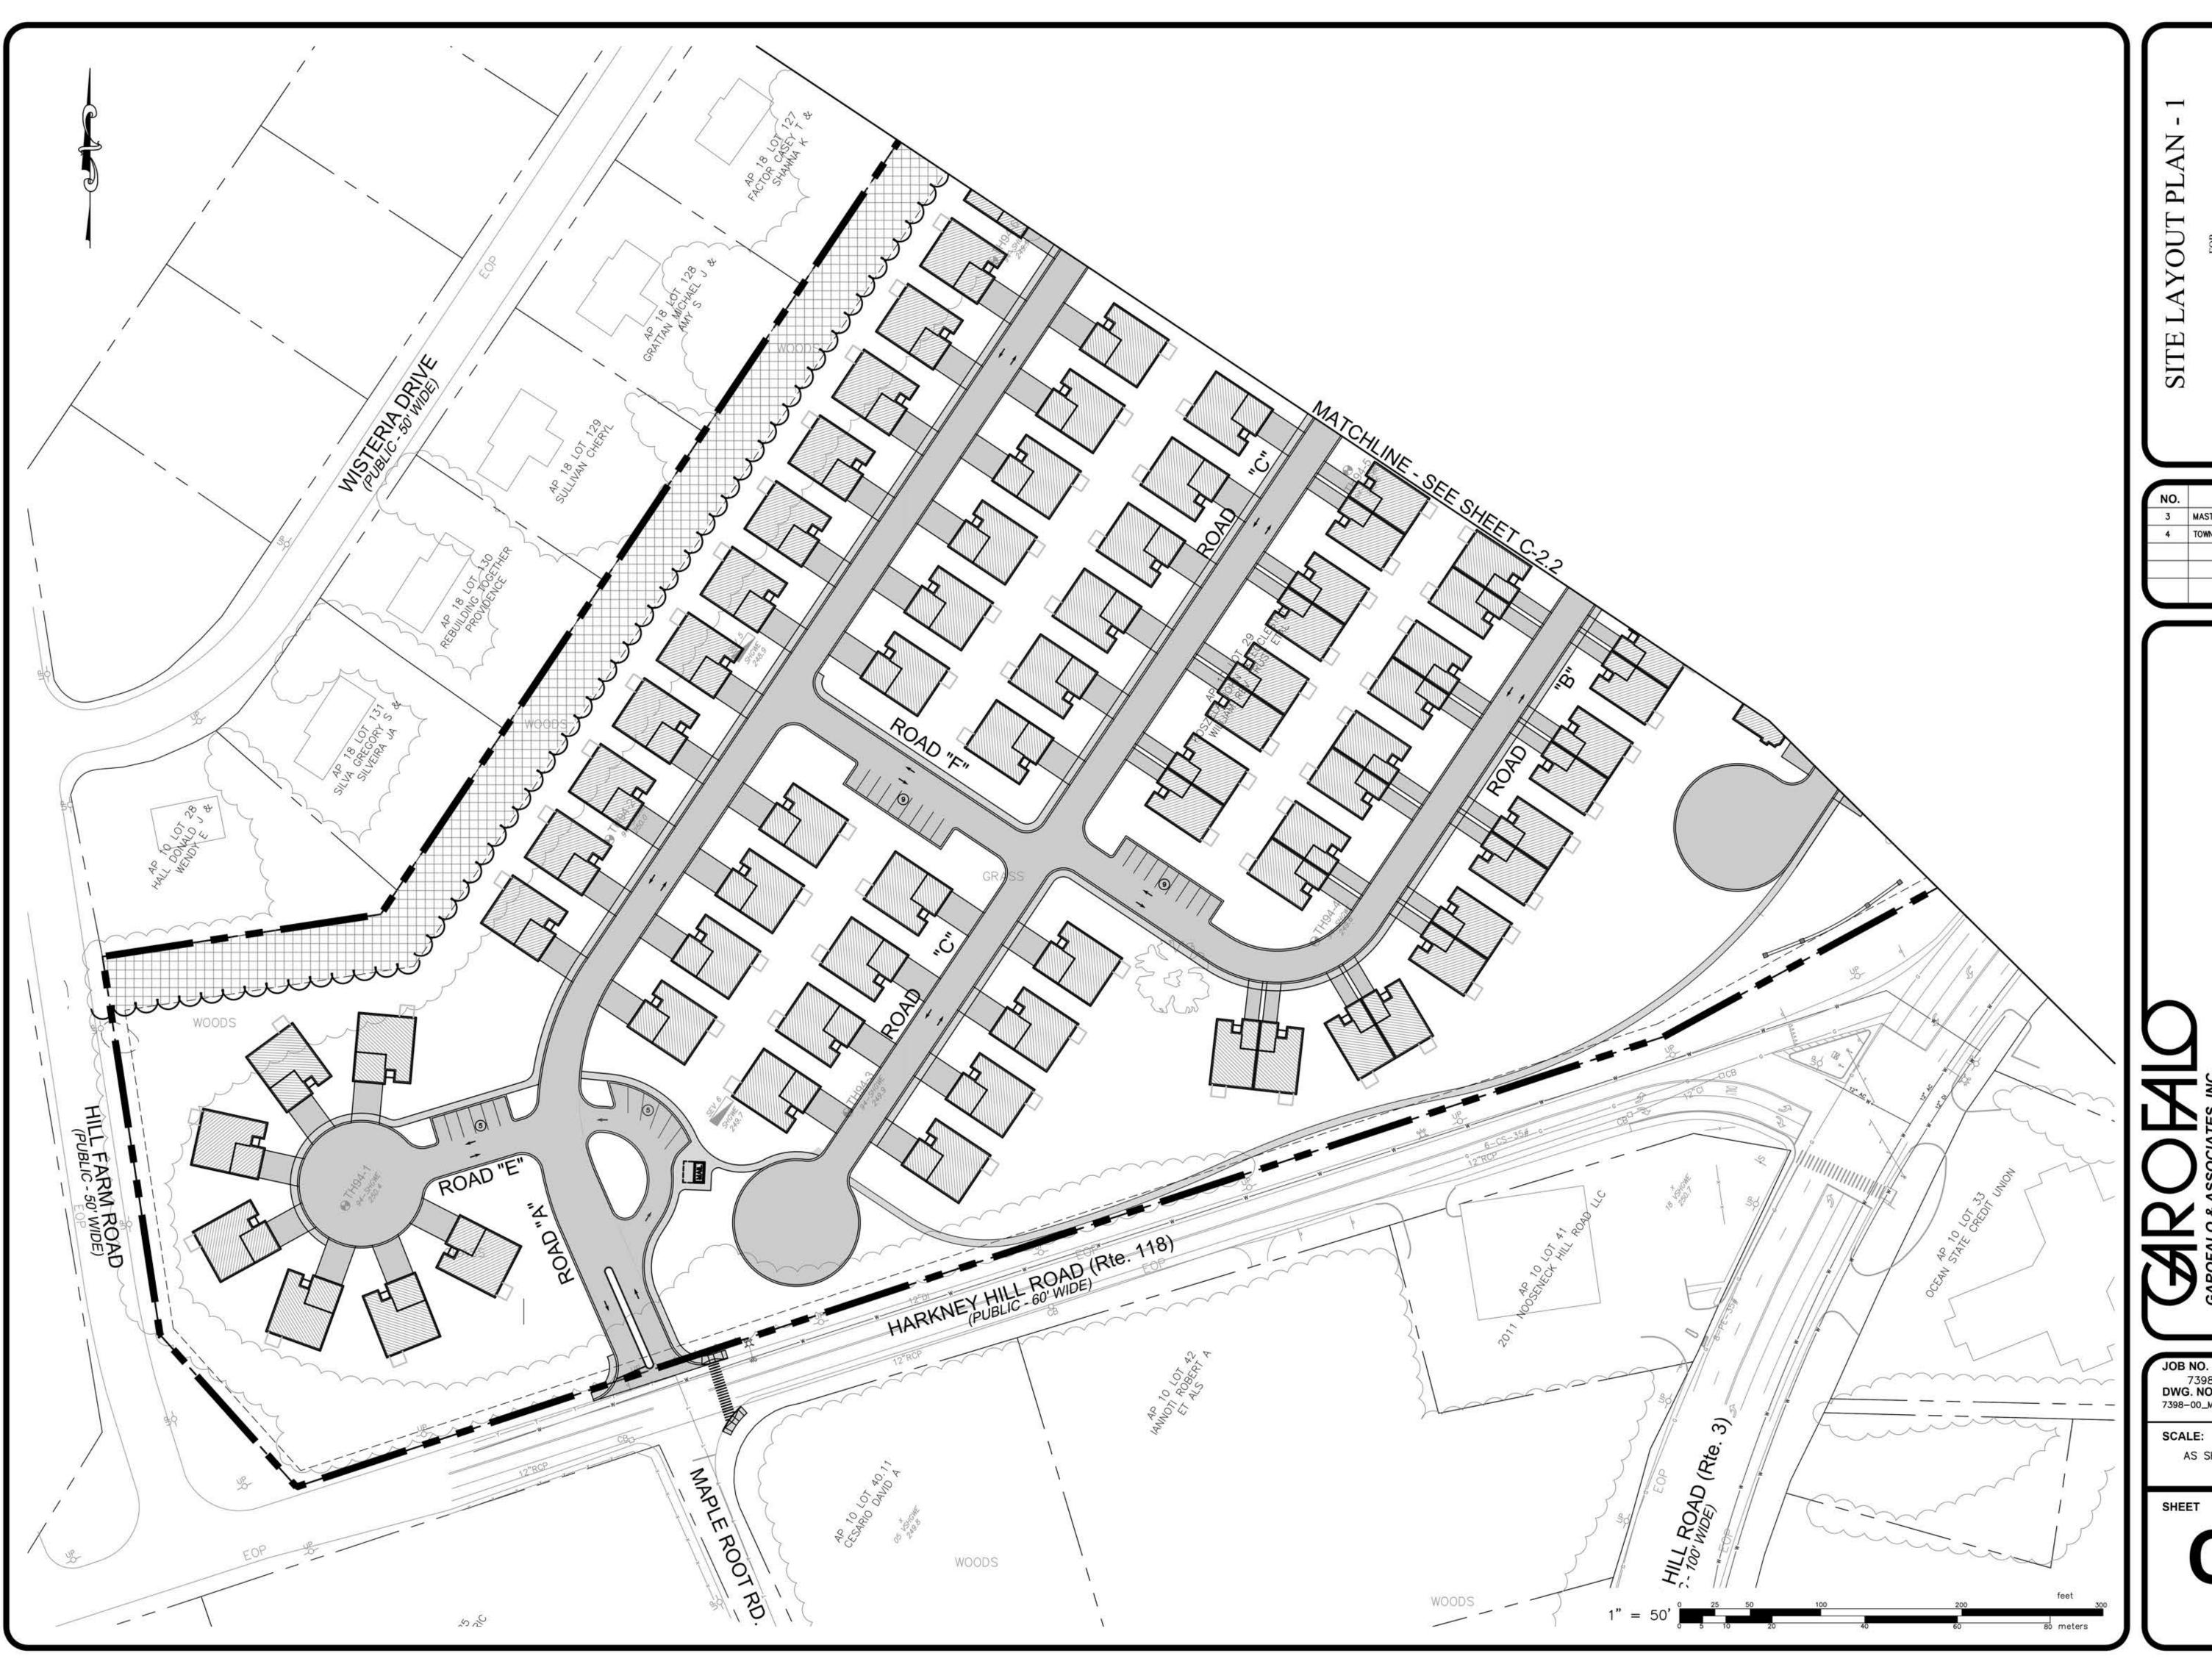
| Ο. | REVISION | BY | DATE |
|----|-----------------------------|-----|----------|
| 5 | MASTER PLAN REVIEW COMMENTS | KJA | 8/18/23 |
| | TOWN COMMENTS | KJA | 10/06/23 |
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PROJECT ENGINEER SAMUEL HEMENWAY

JOB NO. 7398-00 DWG. NO. 7398-00_MP Base.dwg DRAWN BY K.J.A. CHECK BY S.S.H. APPROVED S.B.G.

AS SHOWN DATE: AUGUST, 2023



SITE LAYOUT PLAN - 2

COVENTRY CROSSINGS

(A.P.10, LOT 29 & A.P.18 LOT 86)

SITUATED AT

HARKNEY HILL ROAD

COVENTRY, RI

COVENTRY, RI

| | 1 | BY | DATE |
|---------|-----------------------------|-----|----------|
| · | MASTER PLAN REVIEW COMMENTS | KJA | 8/18/23 |
| <u></u> | TOWN COMMENTS | KJA | 10/06/23 |
| | | | |

PROJECT ENGINEER SAMUEL HEMENWAY

Garofalo & Associates (C)

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7398-00
DWG. NO.
7398-00_MP Base.dwg


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SCALE:

APPROVED S.B.G.

DATE: AUGUST, 2023

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| ١٥. | REVISION | BY | DATE |
|-----|-----------------------------|-----|----------|
| 3 | MASTER PLAN REVIEW COMMENTS | KJA | 8/18/23 |
| 4 | TOWN COMMENTS | KJA | 10/06/23 |
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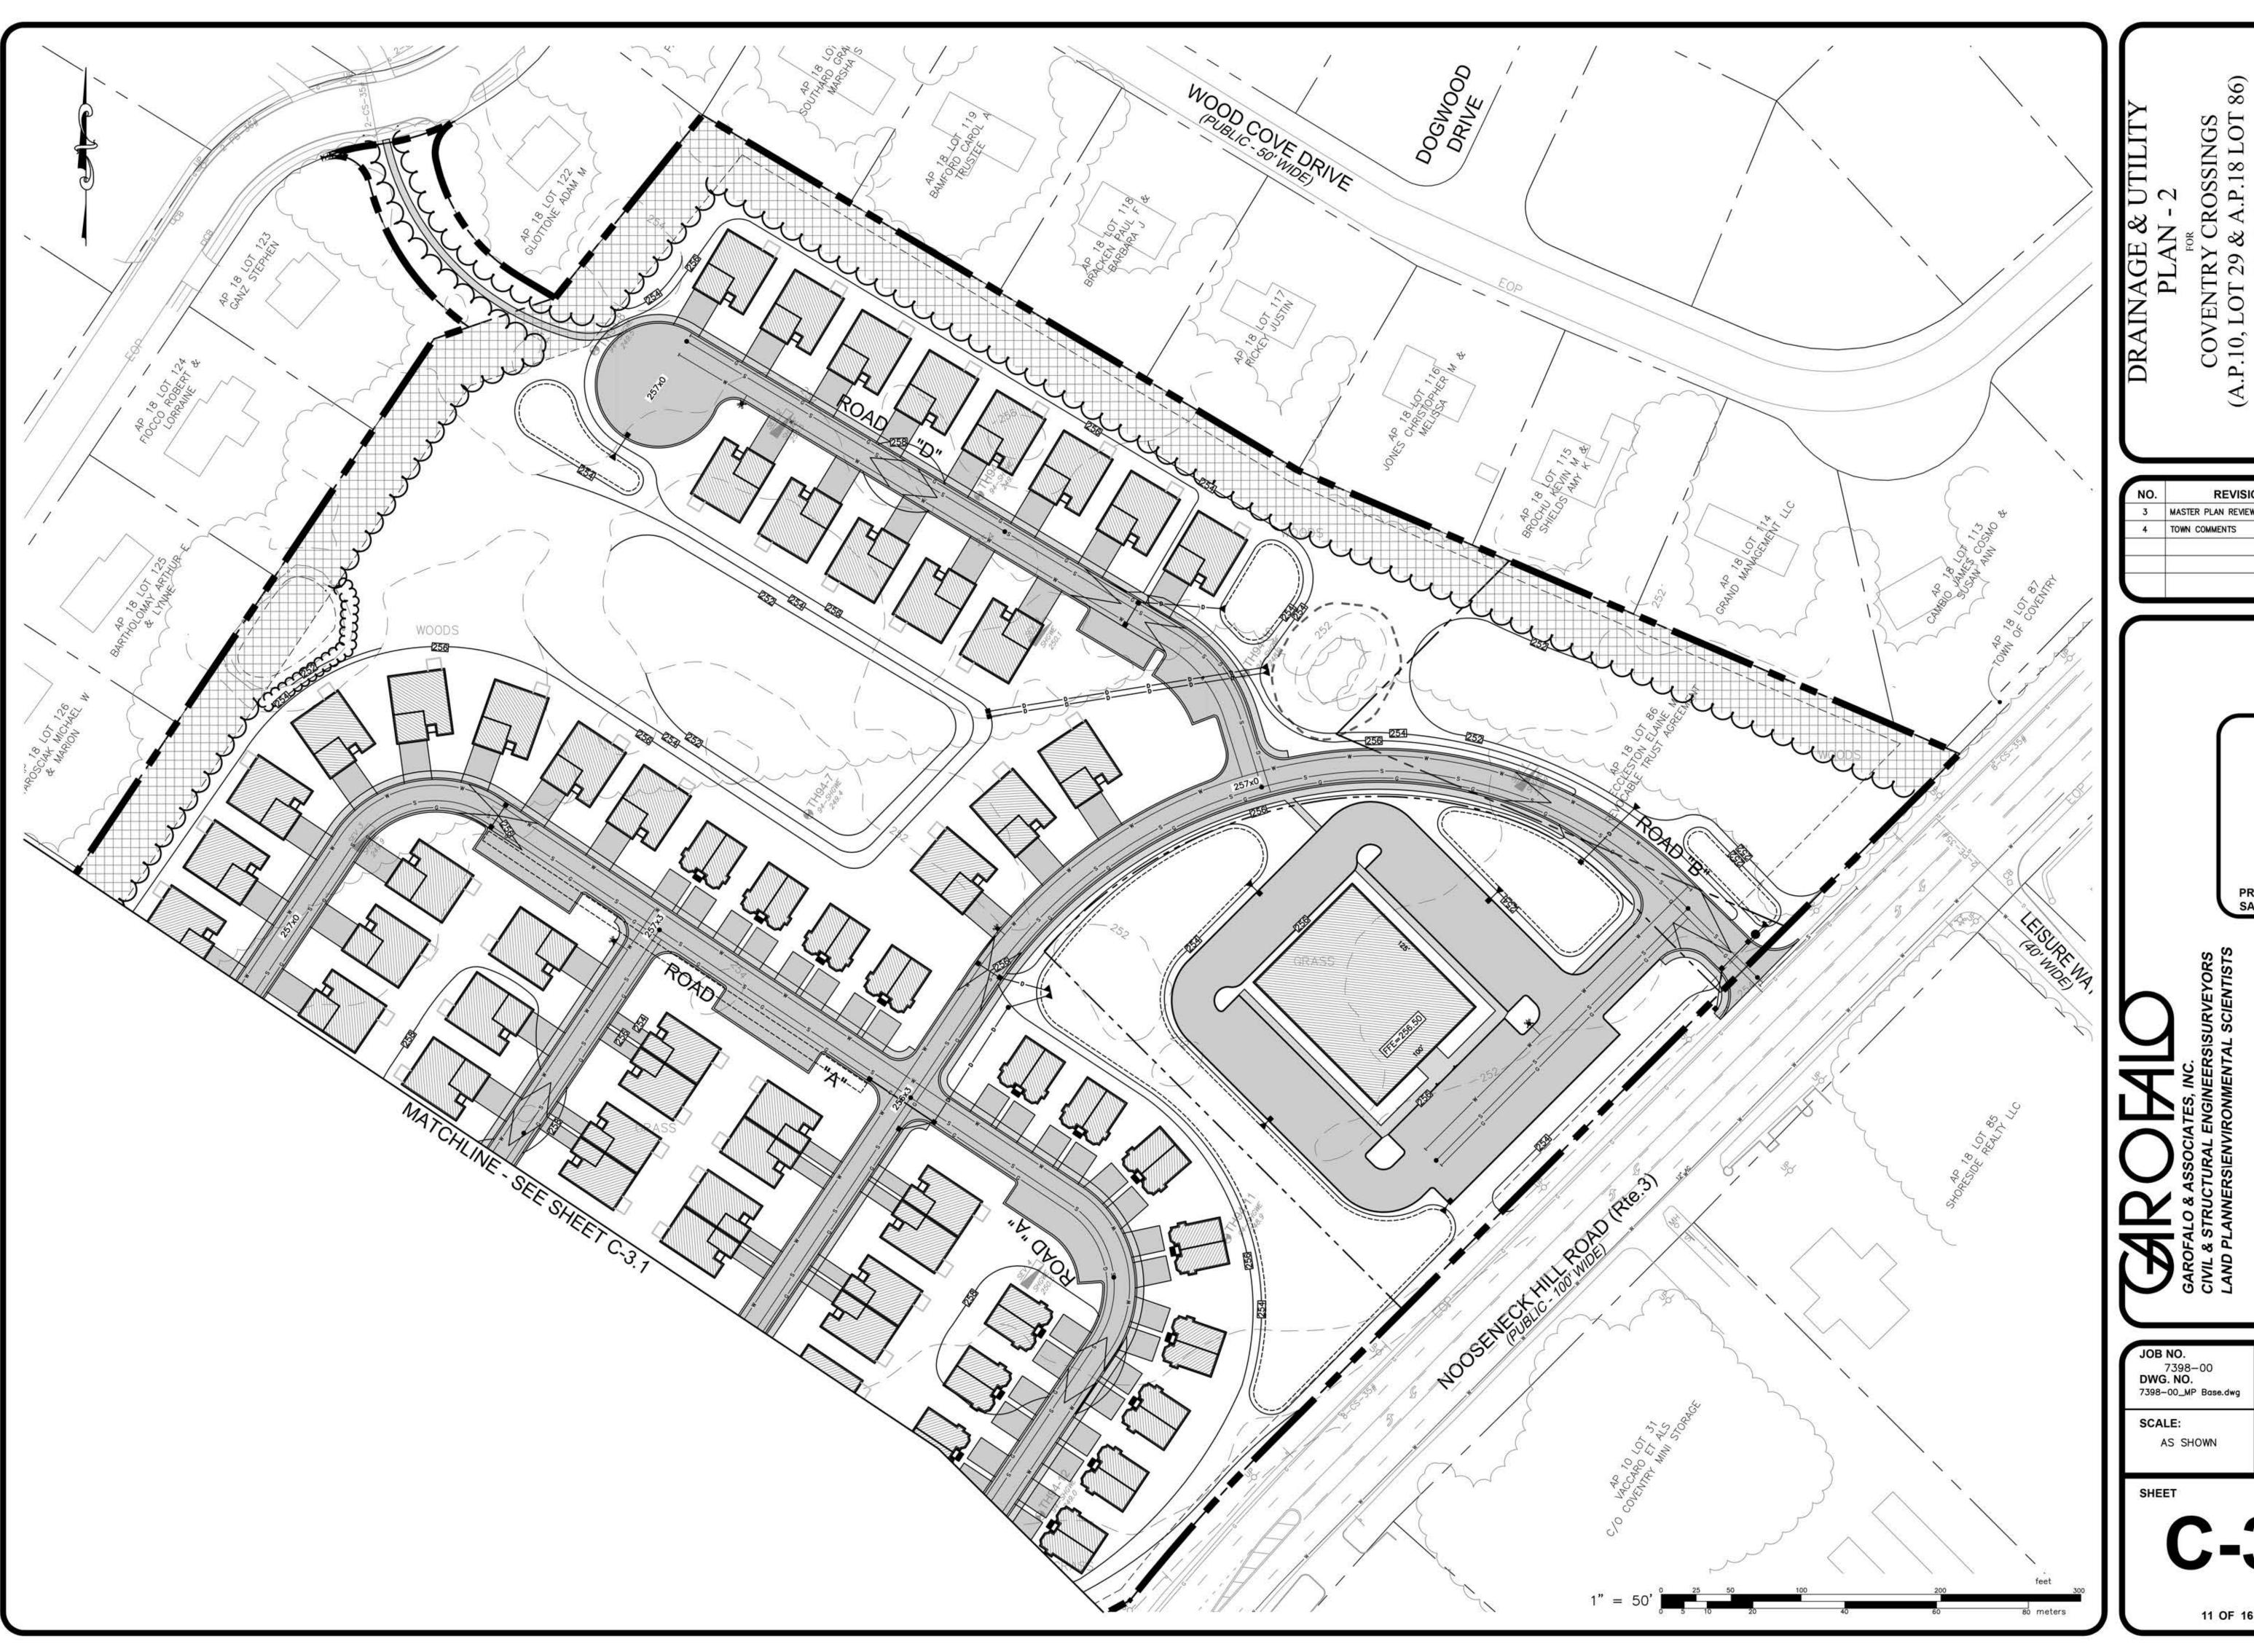
COVENTRY CROSSINGS
(A.P.10, LOT 29 & A.P.18 LOT
SITUATED AT
HARKNEY HILL ROAD
COVENTRY, RI

| REVISION | BY | DATE |
|---------------------------------------|-----------------------------|---------------------------------|
| MASTER PLAN REVIEW COMMENTS | KJA | 8/18/23 |
| TOWN COMMENTS | KJA | 10/06/23 |
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APPROVED S.B.G. DATE: AUGUST, 2023

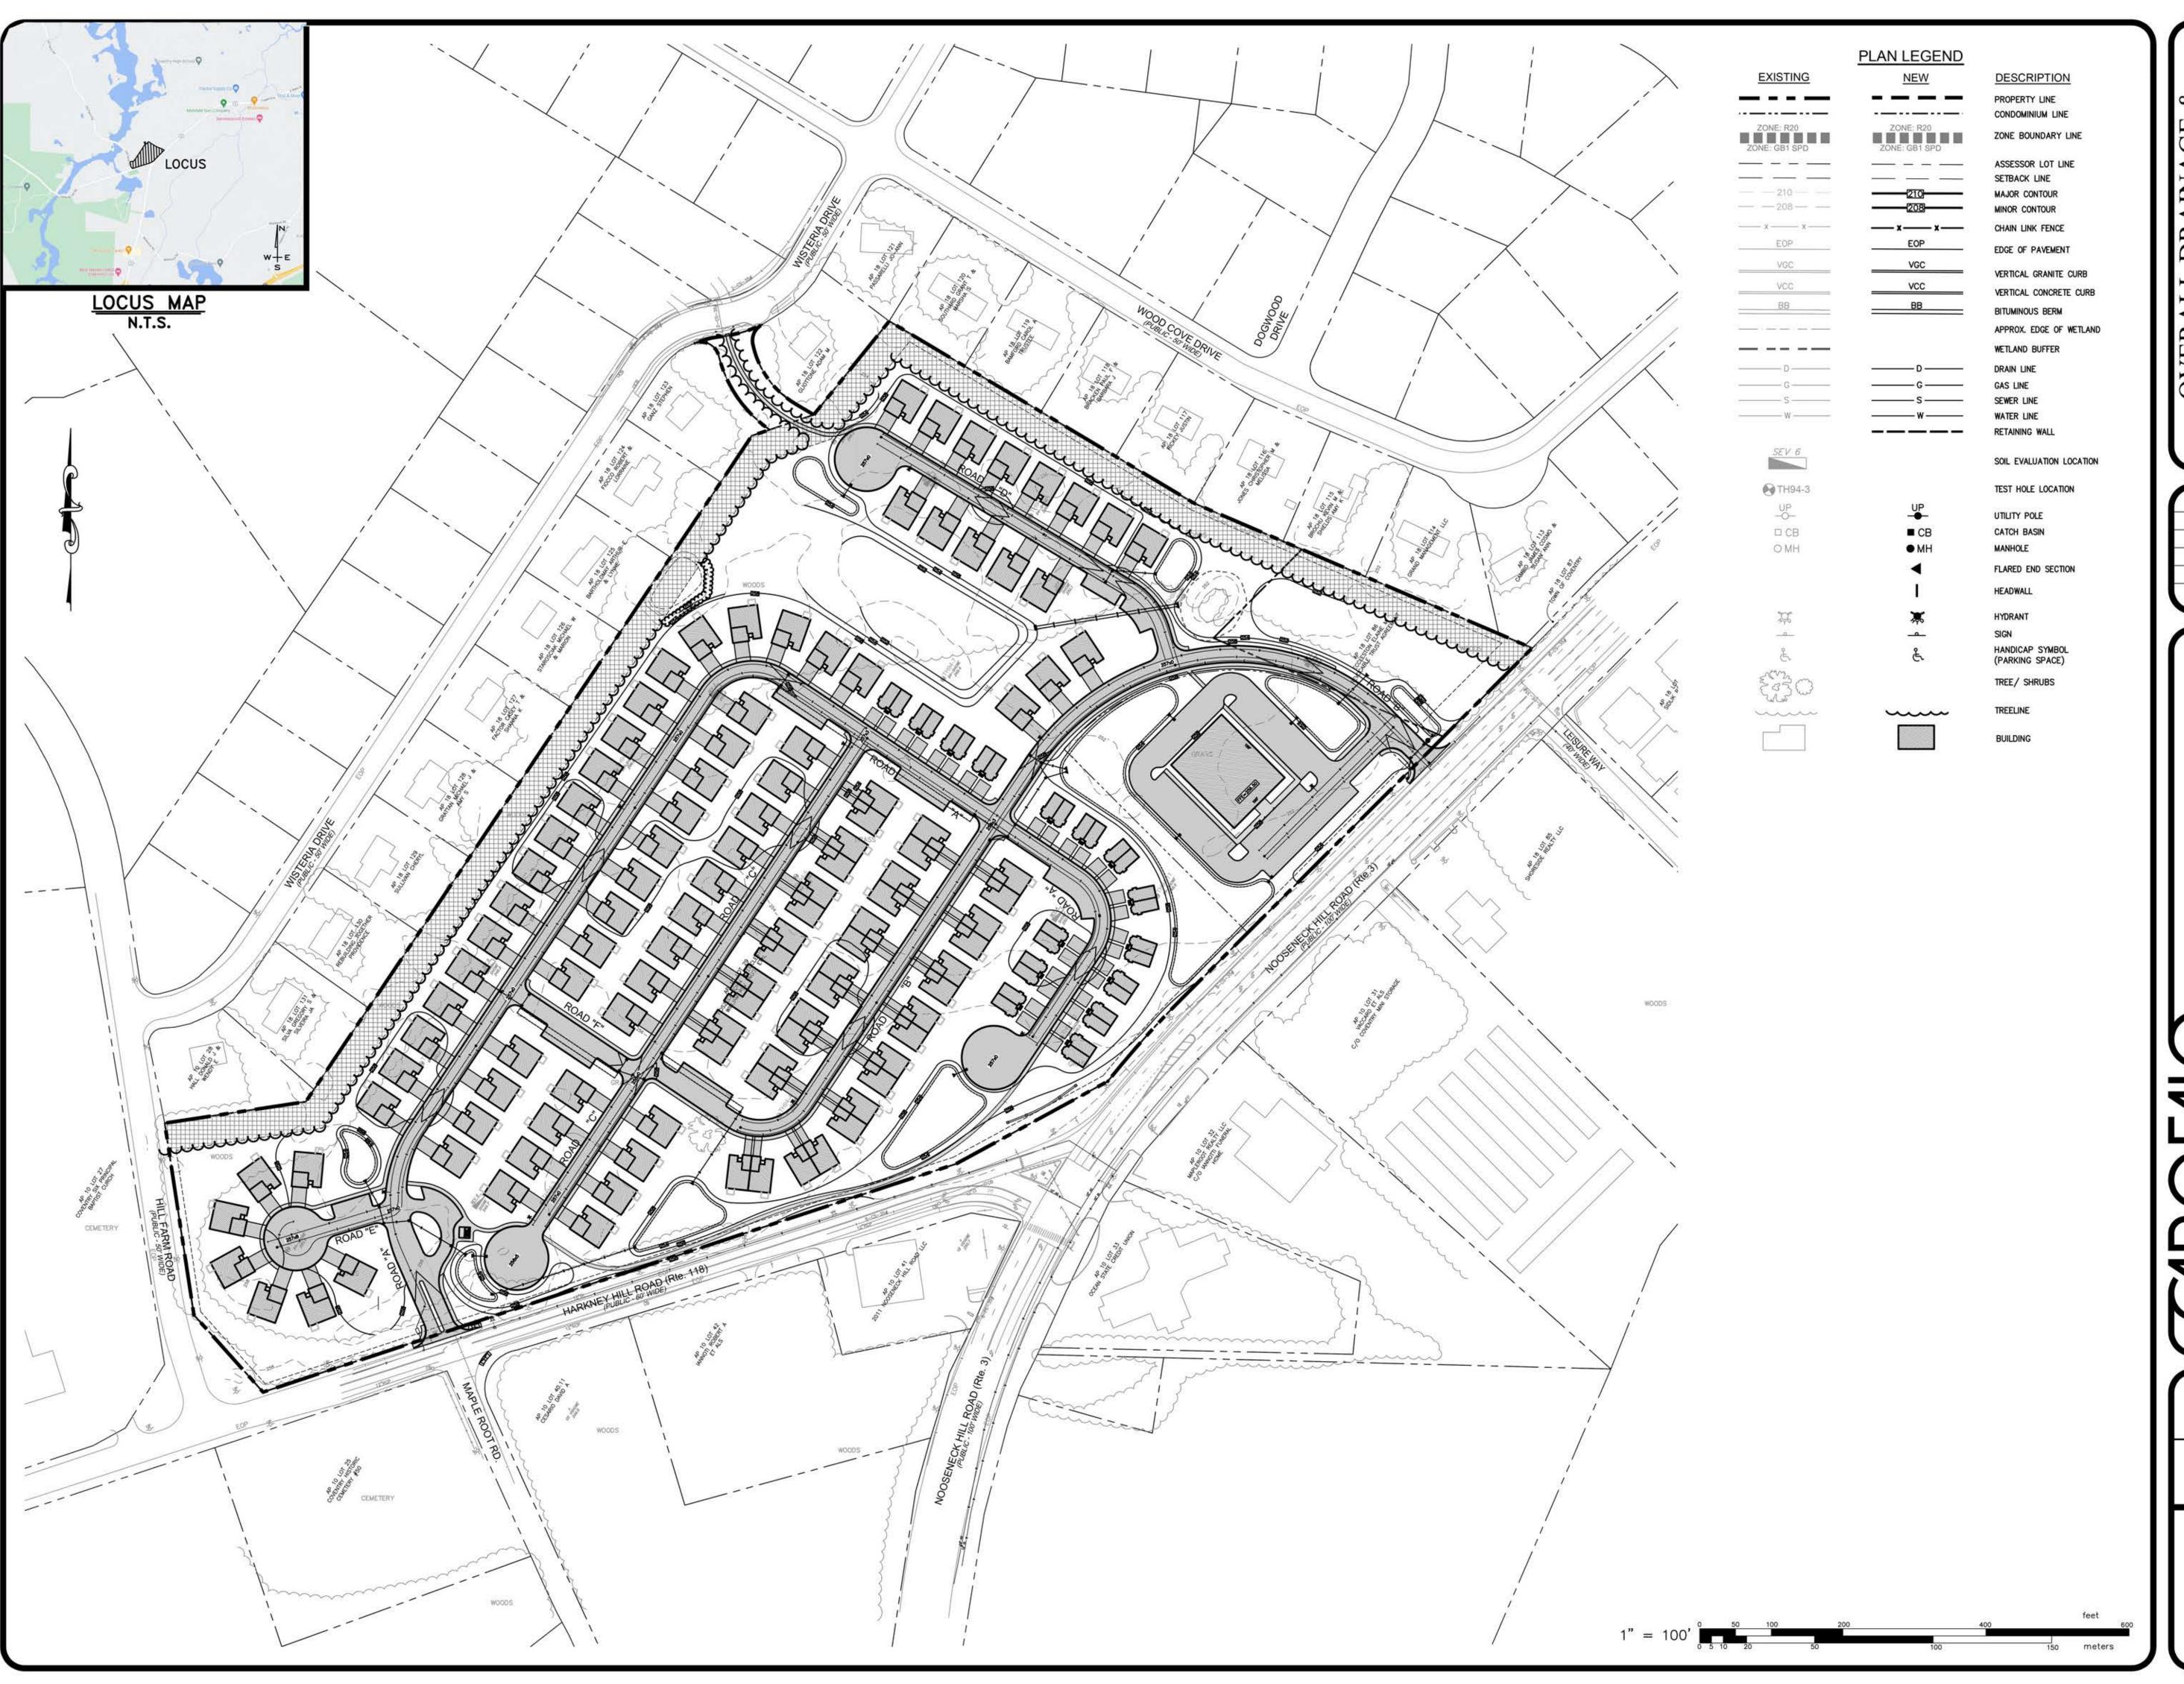

HARKNEY

REVISION MASTER PLAN REVIEW COMMENTS KJA 8/18/23 TOWN COMMENTS KJA 10/06/23

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DATE: AUGUST, 2023



COVENTRY (A.P.10, LOT 29

| REVISION | BY | DATE |
|-----------------------------|-----|---------|
| MASTER PLAN REVIEW COMMENTS | KJA | 8/18/23 |
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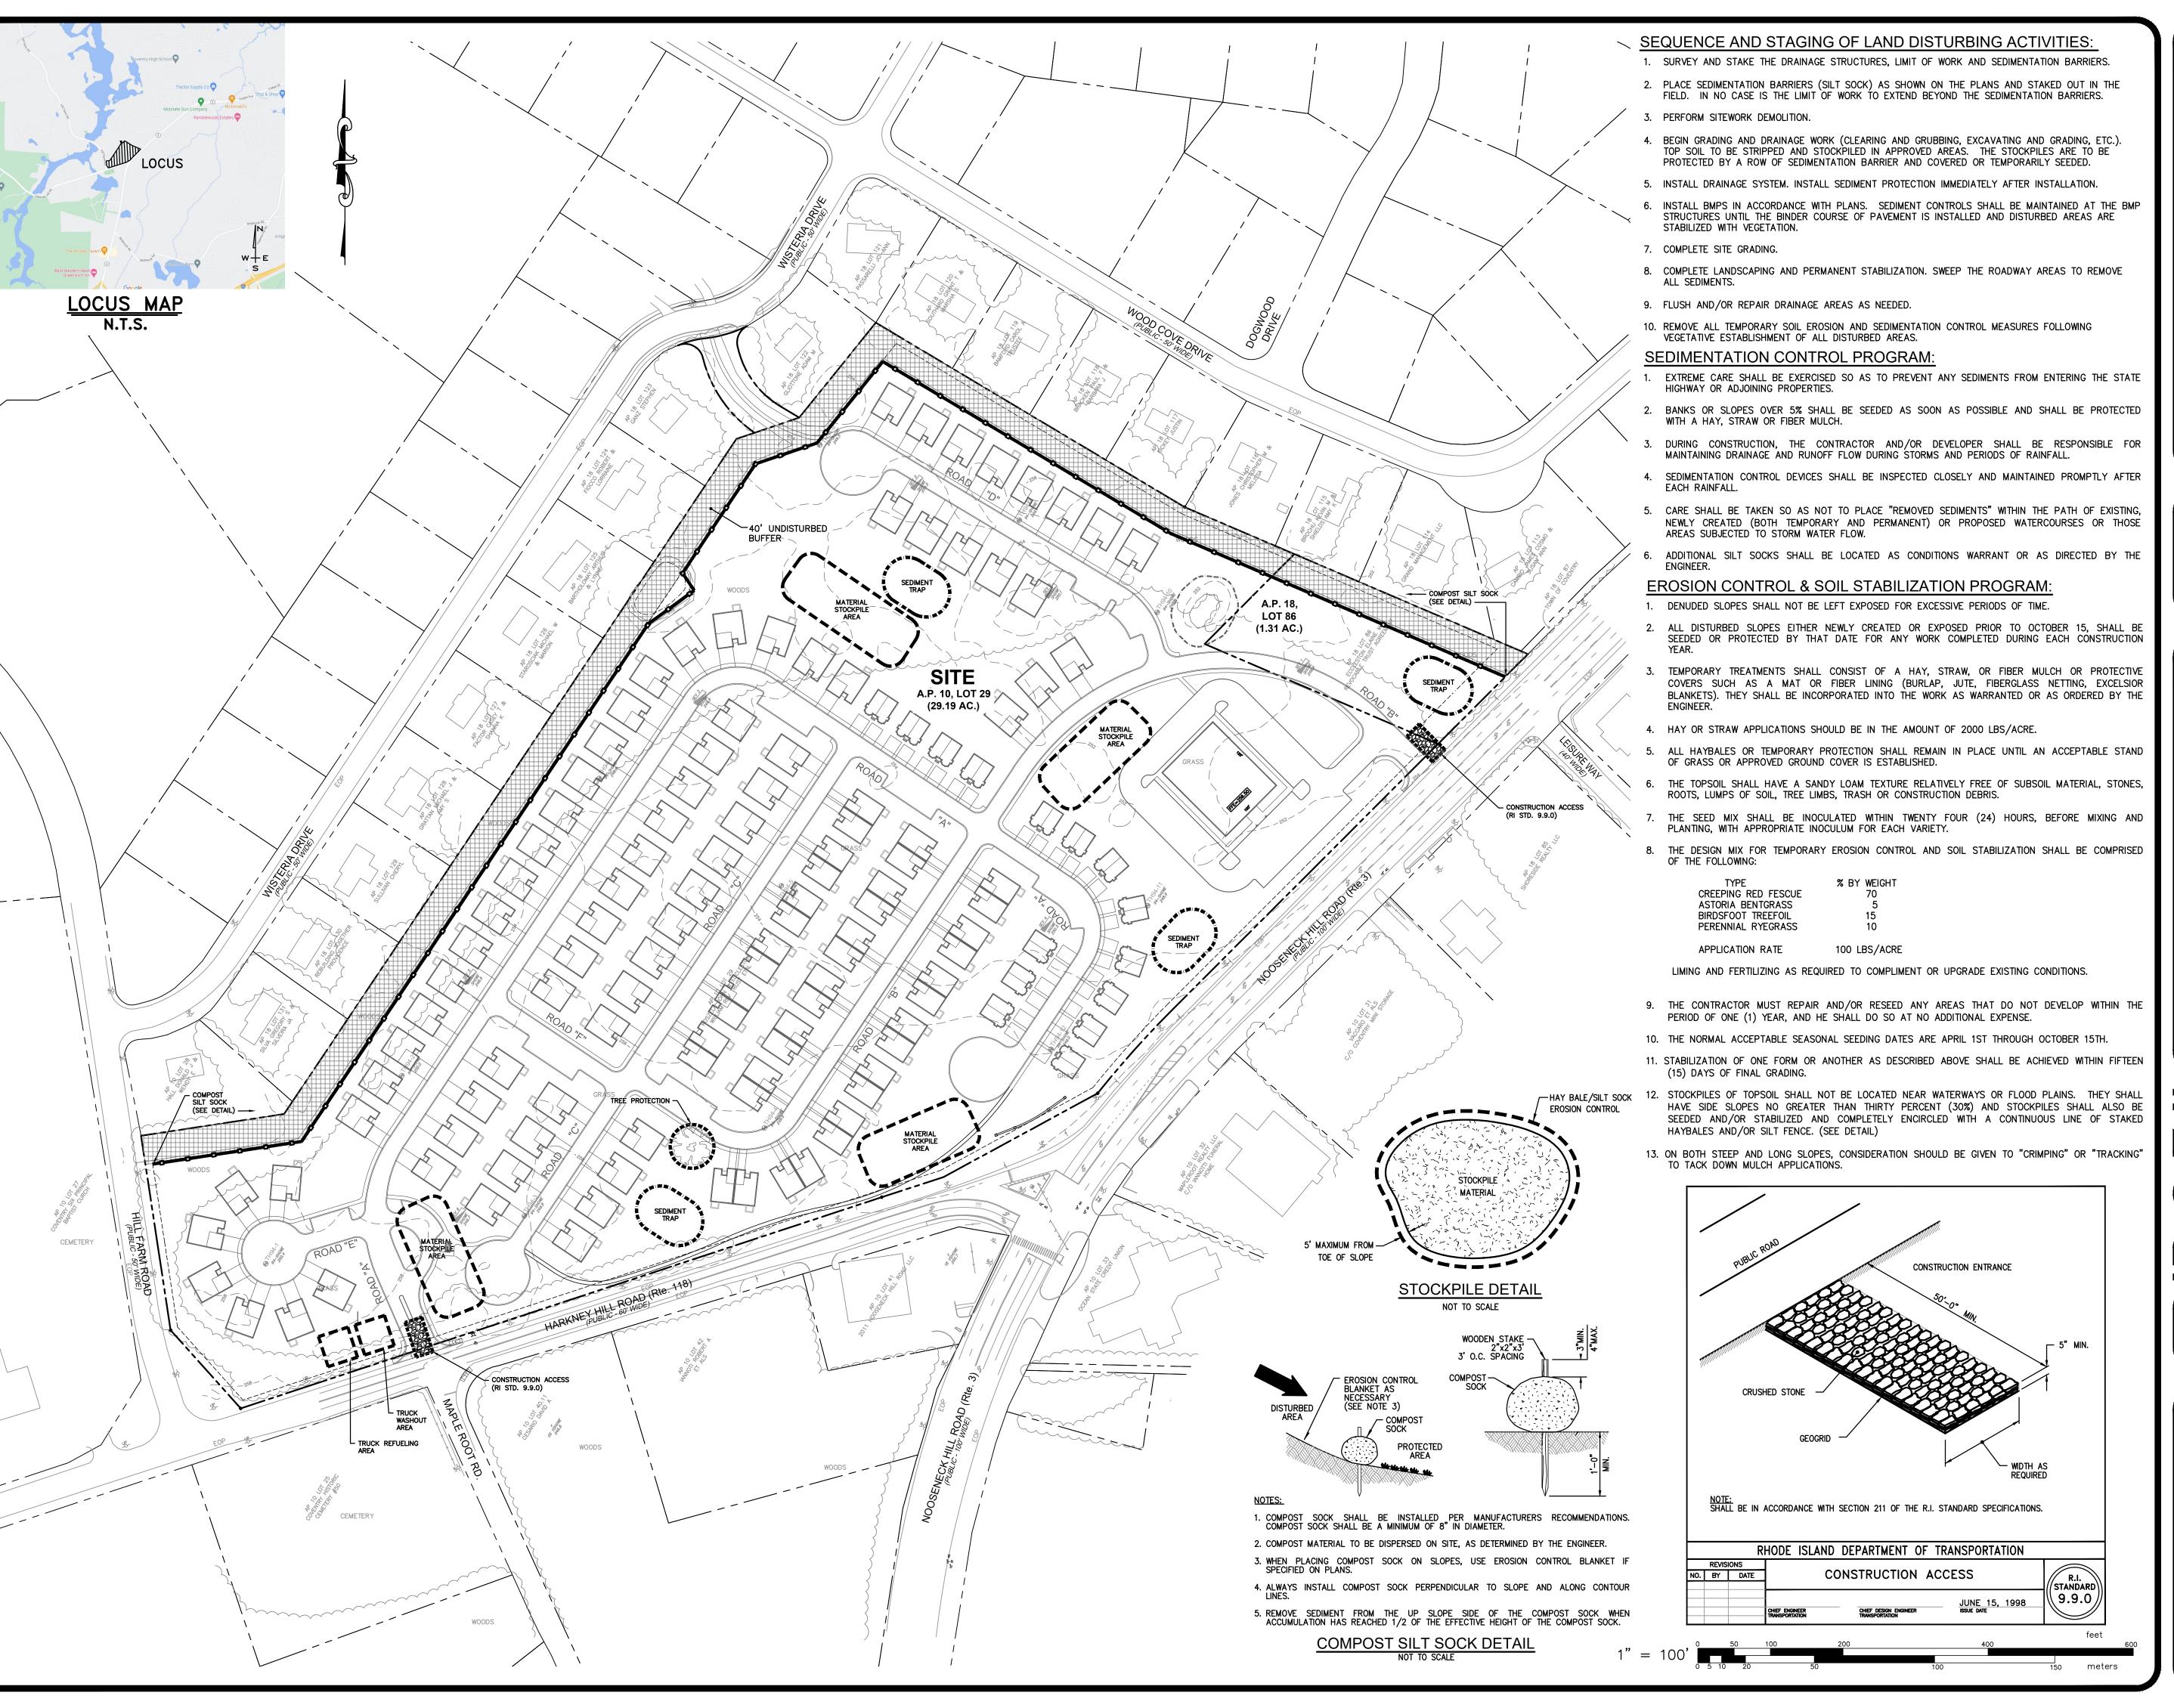
DATE: AUGUST, 2023

JOB NO. 7398-00 DWG. NO.

SCALE:

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AS SHOWN



EROSION & SEDIMENT
CONTROL PLAN
FOR OVENTRY CROSSINGS
10, LOT 29 & A.P.18 LOT 86)
SITUATED AT
AARKNEY HILL ROAD
COVENTRY, RI
PREPARED FOR
REG NEW HOMES, LLC

| NO. | REVISION | BY | DATE |
|-----|-----------------------------|-----|---------|
| 3 | MASTER PLAN REVIEW COMMENTS | KJA | 8/18/23 |
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ORLISS STREET BOX 6145 VIDENCE, R.I. 02940 401-273-6000


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AUGUST, 2023

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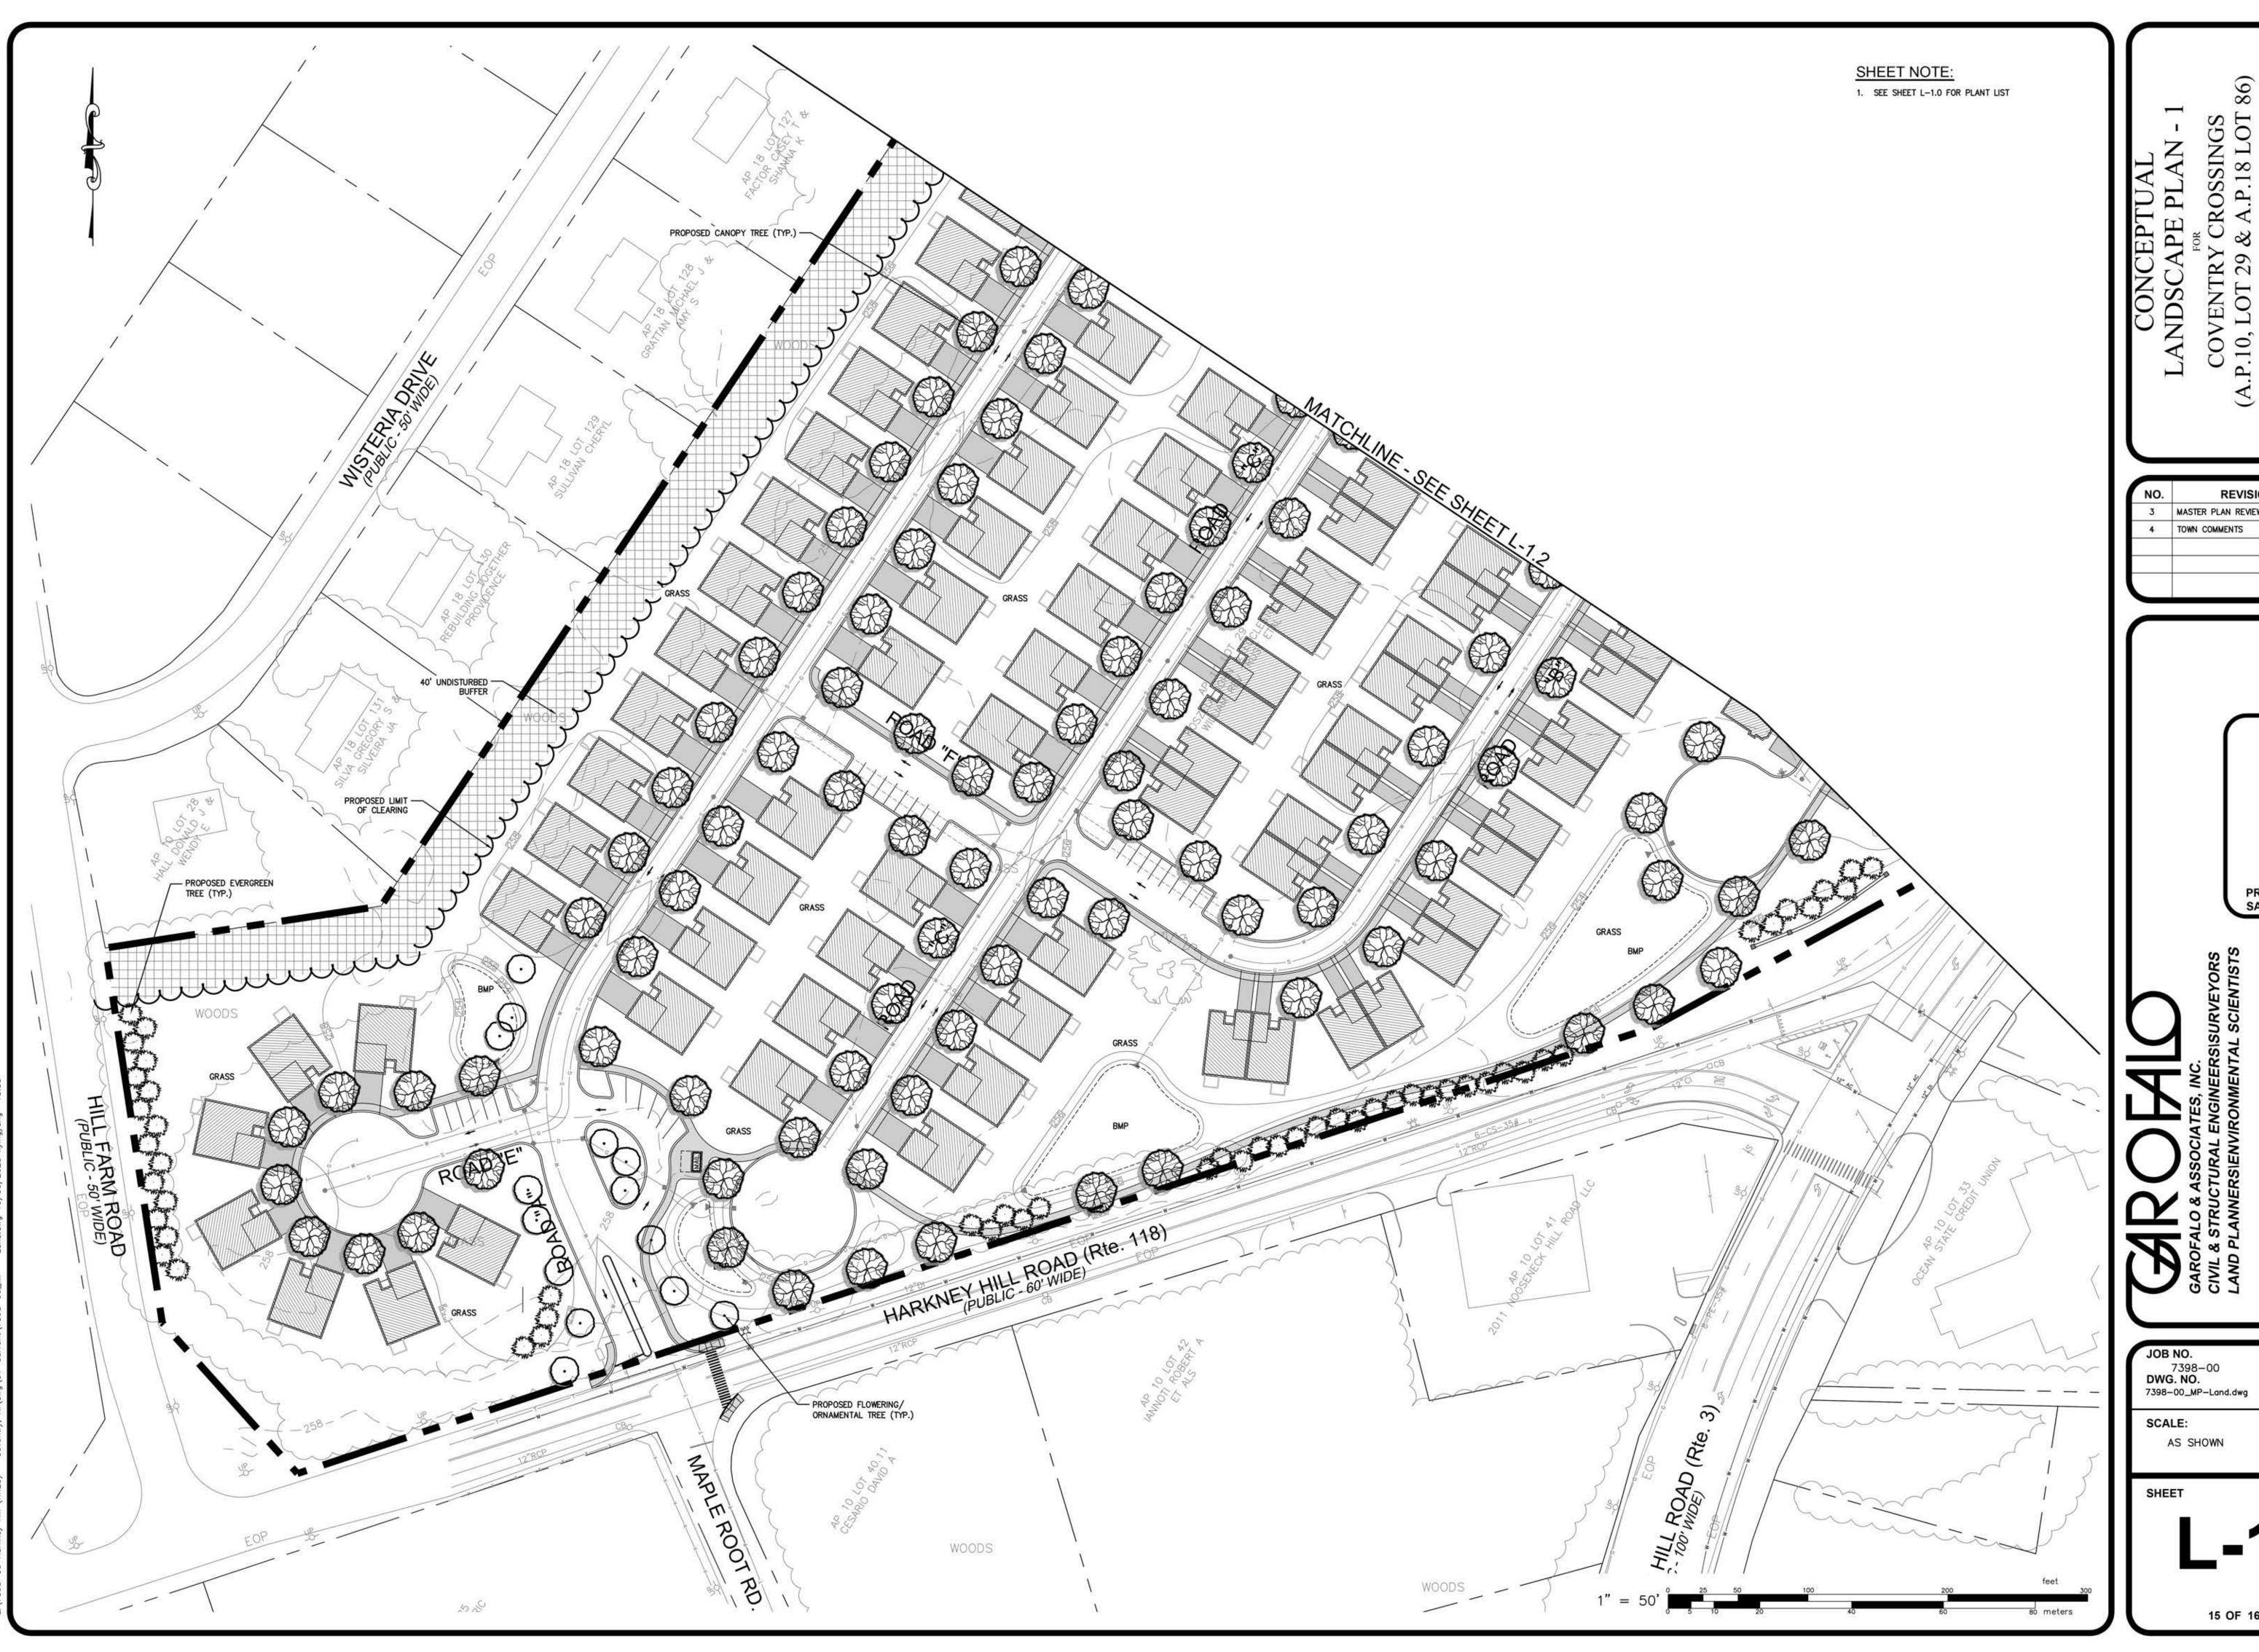
MASTER PLAN REVIEW COMMENTS KJA

PROJECT ENGINEER SAMUEL HEMENWAY

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SCALE: AS SHOWN

APPROVED S.B.G. DATE: AUGUST, 2023

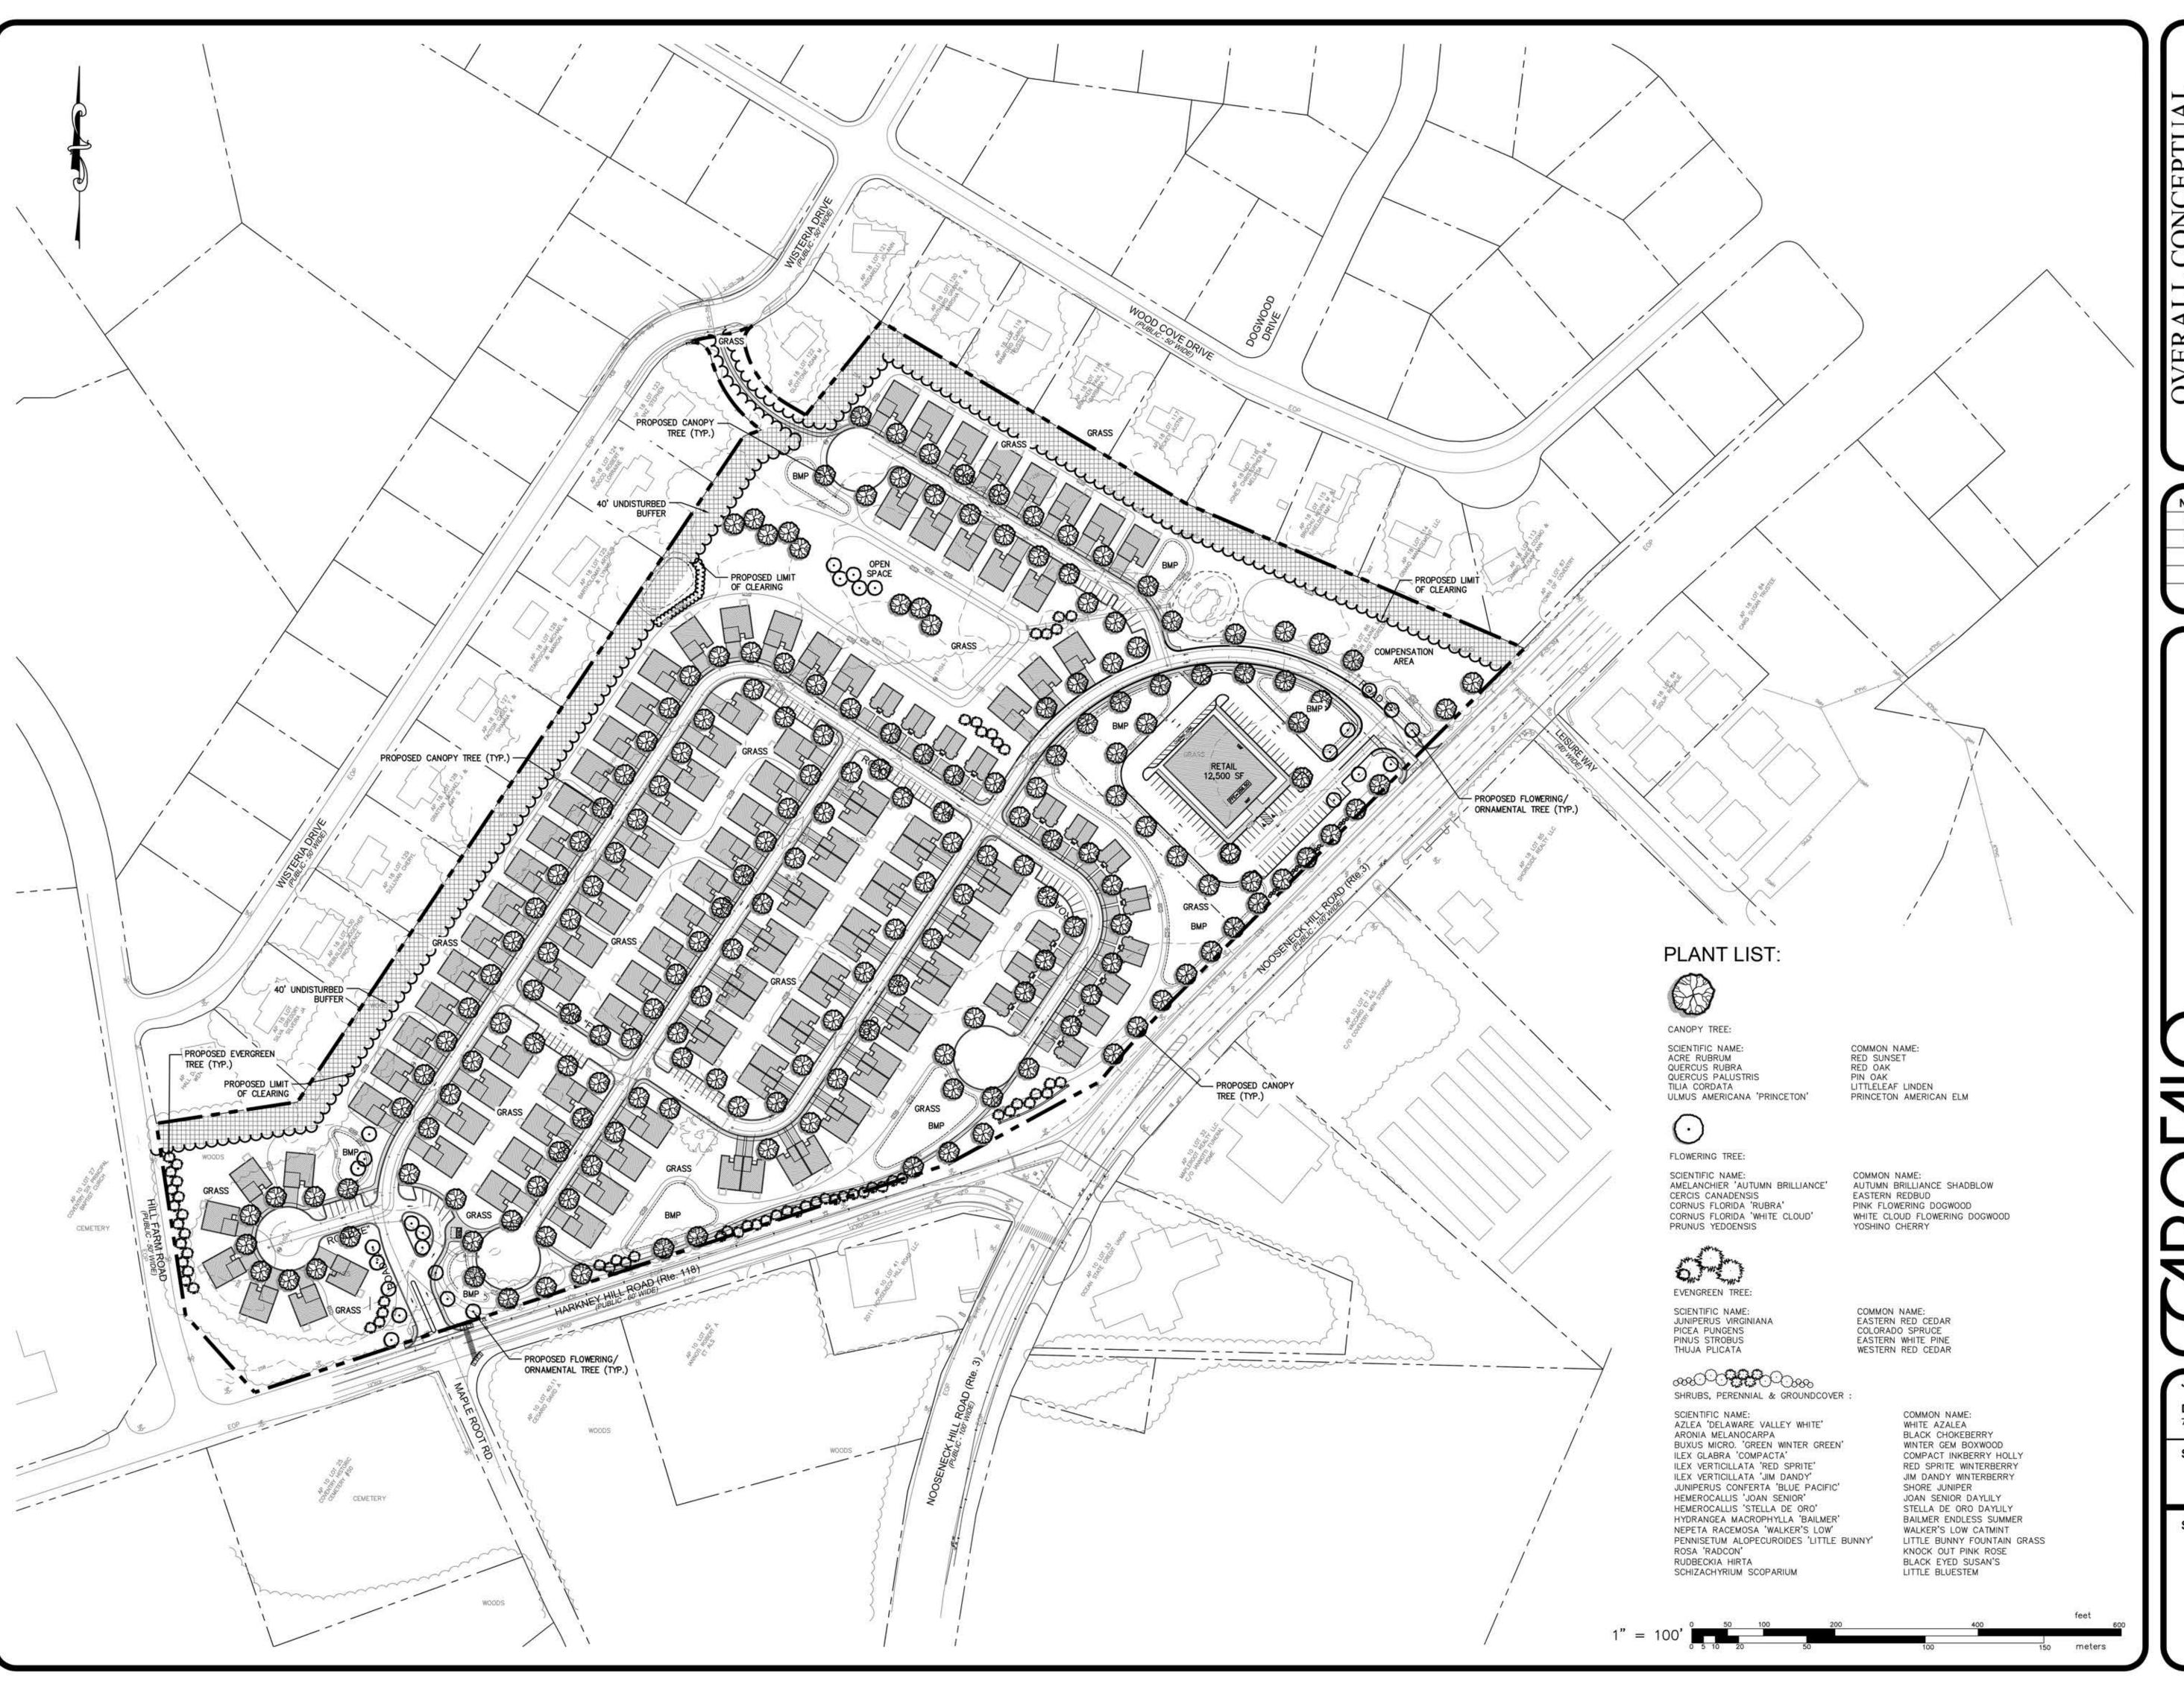

|). | REVISION | BY | DATE |
|----|-----------------------------|-----|----------|
| | MASTER PLAN REVIEW COMMENTS | KJA | 8/18/23 |
| | TOWN COMMENTS | KJA | 10/10/23 |
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PROJECT ENGINEER SAMUEL HEMENWAY

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DRAWN BY K.Y.Y. CHECK BY S.S.H. APPROVED S.B.G.

DATE: AUGUST, 2023

